

SITE NAME:

ATC LEWIS ROAD

SITE NUMBER:

BA90476A

STREET ADDRESS:

6021 LEWIS ROAD VACAVILLE, CA 95687

FILE COPY mu-16-03

PROJECT INFORMATION

TYPE OF CONSTRUCTION:

PROJECT TYPE: SELF SUPPORT TOWER

TOWER INFORMATION:

(LATITUDE & LONGITUDE BASED ON NAD1983) 38.34705556

LONGITUDE: -121.89740000° CENTER HEIGHT: 90' AGI

SQUARE FOOTAGE:

LEASE AREA:

TOWER OWNER: AMERICAN TOWER CORPORATION 19100 VON KARMAN SUITE 200

IRVINE, CA 92612 TEL: (619) 384-2109 PARCEL NUMBER (TAX I.D.) 0142-110-20

OCCUPANT LOAD:

UNOCCUPIED

SUBJECT SITE ZONING:

TOWER SETBACKS:

RFAR.

DRAWING SCALE NOTE: THE DRAWING ARE DESIGNED FOR 11"x17" FORMAT PROJECT SUMMARY

PROJECT DIRECTORY

SCOPE OF WORK

NEW 7'x10' EQUIPMENT CONCRETE PAD WITHIN 8'x10' LEASE AREA

(6) NEW ANTENNAS, (3) NEW RRUS11 B12 & (3) NEW RRUS11 B2

(1) NEW UTILITY H-FRAME WITH NEW TELCO AND PPC CABINET

TOWER OWNER:

IRVINF. CA 92612

PROPERTY SPECIALISTS:

PHONE: (949) 355-2830

AMERICAN TOWER CORPORATION

19100 VON KARMAN SUITE 200

(619) 384-2109

THE DERNA GROUP 22431 ANTONIO PKWY, SUITE B160-234 RANCHO SANTA MARGARITA, CA 92688

DO NOT SCALE DRAWINGS

(1) GPS ANTENNA

APPLICANT:

1855 GATEWAY BLVD.

CONCORD, CA 94520

FULLERTON ENGINEERING

1100 E. WOODFIELD ROAD, SUITE 500 SCHAUMBURG, ILLINOIS 60173

(847) 908-8400

(1) NEW RBS6131 CABINET

(1) NEW 200 AMP METER

(1) NEW (9x18) HYBRID CABLE

(3) NEW SECTOR DUAL PIPE MOUNT

T-MOBILE

SUITE 900

A&E COMPANY:

CONTRACTOR SHALL VERIFY ALL PLANS AND EXISTING DIMENSIONS AND CONDITIONS AT THE PROJECT SITE AND SHALL IMMEDIATELY NOTIFY THE ENGINEER IN WRITING OF ANY DISCREPANCIES BEFORE PROCEEDING WITH THE WORK OR BE RESPONSIBLE FOR SAME.

THE SEAL CERTIFIES ONLY THE CIVIL ENGINEERING DESIGN AND RELATED DETAILS SHOWN ON THESE PLANS. THIS SEAL DOES NOT CERTIFY ANY ARCHITECTURAL. ELECTRICAL, MECHANICAL, STRUCTURAL DESIGN, AND RELATED

FOR SITES WHERE A CRANE IS NECESSARY, THE CONTRACTOR SHALL CONFIRM AN UNOBSTRUCTED ROUTE FOR THE CRANE FROM PUBLIC ROAD TO TOWER SITE PRIOR TO CONSTRUCTION. NO AERIAL OBSTRUCTION UNDER FIFTEEN FEET ABOVE GRADE, INCLUDING AERIAL UTILITY LINES ARE ALLOWED ALONG SIDE OF SAID CRANE ROUTE.

THIS DRAWING IS THE PROPERTY OF FULLERTON ENGINEERING CONSULTANTS, INC. IT IS FOR THE EXCLUSIVE USE OF THIS PROJECT. ANY RE-USE OF THIS DRAWING WITHOUT THE EXPRESSED WRITTEN CONSENT OF FULLERTON ENGINEERING CONSULTANTS, INC. IS PROHIBITED.

now what's below. Call before you dig.

ALL WORK AND MATERIALS SHALL BE PERFORMED AND INSTALLED IN ACCORDANCE WITH THE CURRENT EDITIONS OF THE FOLLOWING CODES AS ADOPTED BY THE LOCAL GOVERNING AUTHORITIES. NOTHING IN THESE PLANS IS TO BE CONSTRUED TO PERMIT WORK NOT CONFORMING TO THE LATEST EDITIONS OF THE FOLLOWING CODES:

2013 CMC (2012 EDITION IAPMO UNIFORM MECHANICAL CODE WITH 2013 CALIFORNIA

2013 CFC (2012 EDITION OF INTERNATIONAL FIRE CODE WITH 2010 CALIFORNIA AMENDMENTS)
2013 CALIFORNIA GREEN CODE, 2013 CALIFORNIA REFERENCES STANDARDS CODE

DRAWING INDEX

APPROVALS

TITLE SHEET GENERAL NOTES

GENERAL NOTES N-2OVERALL SITE PLAN

ENLARGED SITE PLAN C-2EQUIPMENT PLAN

PLATFORM DETAILS TOWER ELEVATION AND ANTENNA DETAILS

C-5 CABINET DETAILS

C-5.1 CABLE DETAILS

OPERATIONS

RF ENGINEER

SITE ACQUISITION

PROPERTY OWNER

POWER APPROVAL

TELCO APPROVAL

ZONING ADMINISTRATOR

T-MOBILE CONSTRUCTION MANAGER

C-5.2 ANTENNA DETAILS & SPEC

C-6 TOWER ELEVATION AND DETAILS

EQUIPMENT DETAILS C-8RFDS SHEET

ELECTRICAL PLAN AND NOTES

ELECTRICAL DETAILS E-3 GROUNDING DETAILS

GROUNDING PLAN AND NOTES

DATE

DATE

DATE

DATE

DATE

DATE

DATE


DATE

T - Mobile:

1855 GATEWAY BLVD. SUITE 900 CONCORD, CA 94520

L700 CONSTRUCTION

CH	ECKED BY:	KI		ᆝ
APF	PROVED BY:	MB		ENGINE
#	DATE	DESCRIPTION	INT.	
0	5/25/16	90% REVIEW	AA	É
0	6/24/16	95% REVIEW	AA	FULLERTON
0	8/1/16	100% REVIEW	AA	Ē
1	8/11/16	FINAL	AA	8
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AMERICAN TOWER CORPORATION 19100 VON KARMAN SUITE 200 IRVINE, CA 92612

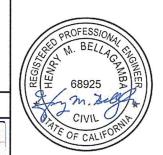

I 100 E. WOODFIELD ROAD, SUITE 500 SCHAUMBURG, ILLINOIS 60173 TEL: 847-908-8400

BA90476A

ATC LEWIS ROAD

SITE ADDRESS:


6021 LEWIS ROAD VACAVILLE, CA 95687

SHEET NAME:

TITLE SHEET

SHEET NUMBER:

2016.0249.0003

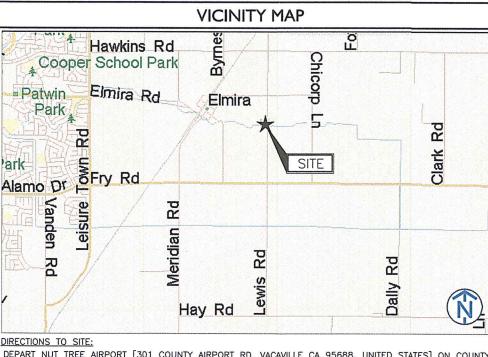

DEPART NUT TREE AIRPORT [301 COUNTY AIRPORT RD, VACAVILLE CA 95688, UNITED STATES] ON COUNTY AIRPORT RD (EAST), ROAD NAME CHANGES TO LOCAL ROAD(S), TAKE RAMP (RIGHT) ONTO 1-80, AT EXIT 57 TURN RIGHT ONTO RAMP, TURN RIGHT (SOUTH) ONTO LEISURE TOWN RD, TURN LEFT (EAST) ONTO HAWKINS RD, TURN RIGHT (SOUTH) ONTO LEWIS RD, TURN RIGHT (WEST) ONTO LOCAL ROAD(S), Arrive AT SITE.

68925

CODE COMPLIANCE

2013 CBC, VOLUME 1 & 2 (2012 EDITION INTERNATIONAL BUILDING CODE WITH 2013

CALIFORNIA AMENDMÈNTS)
CEC (WITH 2015 CALIFORNIA AMENDMENTS)

N/A-EXISTING TOWER

N/A-EXISTING TOWER

N/A-EXISTING TOWER

AMÈNDMENTS)
2013 2013 CALGREEN, CALIFORNIA CODE OF REGULATIONS, PART 6, TITLE 24)

CITY/COUNTY ZONING ORDINANCES

WERE PREPARED UNDER MY DIRECT SUPERVISION AND TO THE BEST OF MY PROFESSIONAL KNOWLEDGE AND BELIEF COMPLY WITH THE REQUIREMENTS OF

ALL APPLICABLE CODES

CERTIFICATION STATEMENT:
I HEREBY CERTIFY THAT THESE PLANS

RODOLFO & CARMEN LOZANO

940 W A ST

DIXON, CA 95620

PART 1 - GENERAL

A. THESE SPECIFICATIONS AND CONSTRUCTION DRAWINGS ACCOMPANYING THEM DESCRIBE THE WORK TO BE DONE AND THE MATERIALS TO BE FURNISHED FOR THE CONSTRUCTION OF THIS

- . THE DRAWINGS AND SPECIFICATIONS ARE INTENDED TO BE FULLY EXPLANATORY AND SUPPLEMENTARY, HOWEVER, SHOULD ANYTHING BE SHOWN, INDICATED OR SPECIFIED ON ONE AND NOT THE OTHER, IT SHALL BE DONE THE SAME AS IF SHOWN, INDICATED OR SPECIFIED IN BOTH.

 C. THE INTENTION OF THE DOCUMENTS IS TO INCLUDE ALL LABOR AND MATERIALS REASONABLY NECESSARY FOR THE PROPER EXECUTION AND COMPLETION OF THE WORK AS STIPULATED IN THE
- D. THE PURPOSE OF THE SPECIFICATIONS IS TO INTERPRET THE INTENT OF THE DRAWINGS AND TO

 B. ERECTION OF FENCE
 DESIGNATE THE METHOD OF THE PROCEDURE, TYPE AND QUALITY OF MATERIAL REQUIRED TO

 C. ACCESS ROAD COMPLETE THE WORK.
- E. MINOR DEVIATIONS FROM THE DESIGN LAYOUT ARE ANTICIPATED AND SHALL BE CONSIDERED AS PART OF THE WORK. NO CHANGES THAT AFTER THE CHARACTER OF THE WORK WILL BE MADE OR PERMITTED BY THE OWNER WITHOUT ISSUING A CHANGE ORDER.

A. THE CONTRACTOR SHALL BE RESPONSIBLE FOR VERIFICATION OF ALL MEASUREMENTS AT THE SITE BEFORE ORDERING ANY MATERIALS OR DOING ANY WORK. NO EXTRA CHARGE OR COMPENSATION SHALL BE ALLOWED DUE TO DIFFERENCE BETWEEN ACTUAL DIMENSIONS AND DUMENSIONS INDICATED ON THE CONSTRUCTION DEFENSIONS ANY SUCH DISCREPANCY IN DIMENSION AND UNIFICATED ON THE CONSTRUCTION DEFORED SUBMITTED TO THE OWNER FOR CONSIDERATION BEFORE THE CONTRACTOR PROCEEDS WITH THE WORK IN THE AFFECTED AREAS.

A MOOT - MICHIGAN DEPARTMENT OF TRANSPORTATION, "STANDARD SPECIFICATIONS FOR CONSTRUCTION," 2003 EDITION.

B ASTM. AMERICAN SOCIETY OF TESTING MATERIALS LATEST EDITION.

B. THE BIDDER, IF AWARDED THE CONTRACT, WILL NOT BE ALLOWED ANY EXTRA COMPENSATION BY REASON OF ANY MATTER OR THING CONCERNING THE WORK WHICH THE BIDDER MIGHT HAVE FULLY DISCOVERED PRIOR TO THE BIDDING.

C. NO PLEA OF IGNORANCE OF CONDITIONS THAT EXIST, OR OF DIFFICULTIES OR CONDITIONS THAT MAY BE ENCOUNTERED OR OF ANY OTHER RELATED MATTER CONCERNING THE WORK TO BE PERFORMED IN THE EXECUTION OF THE WORK WILL BE ACCEPTED AS AN EXCUSE FOR ANY FAILURE OR OMISSION ON THE PART OF THE CONTRACTOR TO FULFILL EVERY DETAIL OF ALL THE

1.3 CONTRACTS AND WARRANTIES

1.3 CONTRACTS AND WARRANTIES

A. EACH CONTRACTOR IS RESPONSIBLE FOR OBTAINING THE BUILDING PERMIT AT THE LOCAL
JURISDICTION AS THE CONTRACTOR OF RECORD, AND PROVIDE TOTAL JURISDICTION WITH ALL
PROOF REQUIRED TO OPERATE AS A CONTRACTOR IN THAT JURISDICTION. THE CONTRACTOR SHALL
BE REIMBURSED ONLY THE AMOUNT OF ANY FEE PAID AS FOLLOWS:

- PLAN REVIEW FEE.
- BUILDING PERMIT FEE.
 CONNECTIONS AND INSPECTIONS FEE. DEVELOPMENT FEE.
- CONTRACTOR IS RESPONSIBLE FOR APPLICATION AND PAYMENT OF CONTRACTOR LICENSES

1.4 STORAGE

ALL MATERIALS MUST BE STORED IN A LEVEL AND DRY FASHION IN A MANNER THAT DOES NOT NECESSARILY OBSTRUCT THE FLOW OF OTHER WORK, ANY STORAGE METHOD MUST MEET ALL RECOMMENDATIONS OF THE ASSOCIATED MANUFACTURER.

1.5 CLEAN UP

THE CONTRACTOR SHALL AT ALL TIMES KEEP THE SITE FREE FROM ACCUMULATION OF WASTE. MATERIAL OR RUBBISH AT THE WORK SITE AND, AT COMPLETION OF THE WORK, SHALL REMOVE ALL RUBBISH FROM AND ABOUT THE BUILDING AREA, INCLUDING ALL TOOLS, EQUIPMENT AND SURPLUS MATERIALS AND SHALL LEAVE THE WORK AREA CLEAN AND READY FOR USE.

1.6 CHANGE ORDER PROCEDURE

CHANGE ORDER MAY BE INITIATED BY THE OWNER ANDIOR THE CONTRACTOR INVOLVED. THE CONTRACTOR, UPON VERBAL REQUEST FROM THE OWNER SHALL PREPARE A WRITTEN PROPOSAL DESCRIBING THE CHANGE IN WORK OR MATERIALS AND ANY CHANGES IN THE CONTRACT AMOUNT AND PRESENT TO THE OWNER FOR APPROVAL SUBMIT REQUESTS OR SUBSTITUTIONS IN THE FORM AND IN ACCORDANCE WITH PROCEDURES REQUIRED FOR CHANGE ORDER PROPOSALS, ANY CHANGES IN SCOPE OF WORK OR MATERIALS WHICH ARE PERFORMED BY THE CONTRACTOR WITHOUT A WRITTEN CHANGE ORDER AS DESCRIBED AND APPROVED BY THE OWNER SHALL PLACE FULL RESPONSIBILITY OF THESE ACTIONS ON THE CONTRACTOR.

1.7 RELATED DOCUMENTS AND COORDINATION

GENERAL CARPENTRY, ELECTRICAL AND ANTENNA DRAWINGS ARE INTERRELATED. IN PERFORMANCE OF THE WORK, THE CONTRACTOR MUST REFER TO ALL DRAWINGS. ALL COORDINATION TO BE THE RESPONSIBILITY OF THE CONTRACTO

1.8 PRODUCTS AND SUBSTITUTIONS

A. SUBMIT 3 COPIES OF EACH REQUEST FOR SUBSTITUTION. IN EACH REQUEST IDENTIFY THE PRODUCT OR FABRICATION OR INSTALLATION METHOD TO BE REPLACED BY THE SUBSTITUTION. INCLUDE RELATED SPECIFICATION SECTION AND DRAWING NUMBERS AND COMPLETE DOCUMENTATION SHOV(ING COMPLANCE WITH THE REQUIREMENTS FOR SUBSTITUTIONS.

B. SUBMIT ALL NECESSARY PRODUCT DATA AND CUT SHEETS WHICH PROPERLY INDICATE AND

DESCRIBE THE ITEMS PRODUCTS AND MATERIALS BEING INSTALLED. THE CONTRACTOR SHALL IF DEEMED NECESSARY BY THE OWNER, SUBMIT ACTUAL SAMPLES TO THE OWNER FOR APPROVAL I LIEU OF CUT SHEETS.

1.9 QUALITY ASSURANCE

ALL WORK SHALL BE IN ACCORDANCE WITH APPLICABLE LOCAL, STATE AND FEDERAL REGULATIONS. 2.1 MATERIAL

BUT NOT BE LIMITED TO THE LATEST VERSION OF THE FOLLOWING: ANSI/EIA - 222 · E

LINIFORM BUILDING CODE (URC)

2006 BUILDING OFFICIALS AND CODE ADMINISTRATORS (BOCA 2006)
NATIONAL ELECTRICAL CODE (NEC) WITH LOCAL AMENDMENTS UNDERWRITER LABORATORIES APPROVED ELECTRICAL PRODUCTS
AMERICAN INSTITUTE OF STEEL CONSTRUCTION SPECIFICATIONS (AISC) LIFE SAFETY CODE NFPA - 101

MINIMUM DESIGN CRITERIA FOR STEEL ANTENNA TOWERS AND SUPPORTING STRUCTURES WILL BE TIA / EIA - 222 - F

A. PRIOR TO THE COMMENCEMENT OF ANY WORK, THE CONTRACTOR WIII ASSIGN A PROJECT MANAGER WHO WILL ACT AS A SINGLE POINT OF CONTACT FOR ALL PERSONNEL INVOLVED IN THIS PROJECT. THIS PROJECT MANAGER WILL DEVELOP A MASTER SCHEDULE FOR THE PROJECT WHICH WILL BE SUBMITTED TO THE OWNER PRIOR TO THE COMMENCEMENT OF

B. SUBMIT A BAR CHART TYPE PROGRESS NOT MORE THAN 3 DAYS AFTER THE DATE ESTABLISHED CORDINATED WITH OTHER ELEMENTS OF WORK. SHOW COMPLETION OF THE WORK SUFFICIENTLY

CORDINATED WITH OTHER ELEMENTS OF WORK. SHOW COMPLETION OF THE WORK SUFFICIENTLY IN ADVANCE OF THE DATE ESTABLISHED FOR SUBSTANTIAL COMPLETION OF THE WORK.

C. PRIOR TO COMMENCING CONSTRUCTION, THE OWNER WILL SCHEDULE AN "ON-SITE" MEETING WITH ALL MAJOR PARTIES. THIS WOULD INCLUDE (THOUGH NOT LIMITED TO) THE OWNER, LOCAL TELEPHONE COMPANY, TOWER ERECTION FOREMAN (IF SUBCONTRACTED).

D. CONTRACTOR SHALL BE EQUIPPED WITH SOME MEANS OF CONSTANT COMMUNICATIONS, SUCH AS A MOBILE PHONE OR A PAGER. THIS EQUIPMENT WILL NOT BE SUPPLIED OR PAID FOR BY THE OWNER NOR WILL CELLULAR SERVICE BE ARRANGED

OWNER NOR WILL GELLULAR SERVICE DE MERANGEU. E, DURING CONSTRUCTION, CONTRACTOR MUST ENSURE THAT EMPLOYEES AND SUBCONTRACTORS WEAR OSHA LEVEL D PERSONAL PROTECTIVE EQUIPMENT AT ALL TIMES. THE CONTRACTOR MUST COMPLY WITH ALL APPLICABLE OSHA REQUIREMENTS.

F. CONTRACTOR SHALL PROVIDE DAILY UPDATES ON SITE PROGRESS. FITHER VERBAL OR WRITTEN. A COMPLETE INVENTORY OF CONSTRUCTION MATERIALS AND EQUIPMENT IS REQUIRED PRIOR TO START OF CONSTRUCTION.

DIVISION 2 - SITE WORK PART 1 - GENERAL

1.1 WORK INCLUDED

REFER TO THE SURVEY AND ARCHITECTURAL SITE PLAN FOR WORK INCLUDED

12 RELATED WORK

A. INSTALLATION OF ANTENNA SYSTEM

- C. ACCESS ROAD
- D. PARKING AREA

1.3 DESCRIPTIONS

ACCESS ROAD, TURNAROUND AREAS, AND SITES ARE CONSTRUCTED TO PROVIDE A WELL DRAINED. EASILY MAINTAINED, EVEN SURFACE FOR MATERIAL AND EQUIPMENT DELIVERIES AND TENANCE PERSONNEL ACCESS.

1.4 REFERENCES

B. ASTM - AMERICAN SOCIETY OF TESTING MATERIALS, LATEST EDITION.

1.5 QUALITY ASSURANCES

A. CONTRACTOR SHALL APPLY SOIL STERILIZER IN ACCORDANCE WITH MANUFACTURER'S RECOMMENDATIONS, AS NEEDED.

B. VEGETATION AND LANDSCAPING. IF REQUIRED WITHIN THE CONTRACT, SHALL BE PLACED AND MAINTAINED AS RECOMMENDED BY NURSERY INDUSTRY STANDARDS.

A. CONTRACTOR SHALL CONFIRM SURVEY STAKES AND SET ELEVATION STAKES PRIOR TO ANY CONSTRUCTION

B. THE COMPLETE ROAD AND SITE AREA SHALL BE CLEARED OF HEAVY GROWTH OF GRASS. TREES. SHRUB AND TOPSOIL PRIOR TO FOUNDATION CONSTRUCTION OR PLACEMENT OF BLACKFILL OR SUBBASE MATERIAL.

C. CONSTRUCT TEMPORARY CONSTRUCTION ZONE ALONG ACCESS DRIVE

D. THE SITE AREA SHALL BE BROUGHT TO SUBBASE COURSE ELEVATION AND THE ACCESS ROAD TO BASE COURSE ELEVATION PRIOR TO FORMING FOUNDATIONS.

E. CONTRACTOR SHALL APPLY SOIL HERBICIDE PRIOR TO PLACING BASE MATERIALS. F. IF REQUIRED, GRADE, SEED, FERTILIZE AND MULCH DISTURBED AREA IMMEDIATELY AFTER BRINGING THE SITE AND ACCESS ROAD TO BASE COURSE ELEVATION PRIOR TO FORMING

G. REMOVE GRAVEL FROM TEMPORARY CONSTRUCTION ZONE.

H. AFTER APPLICATIONS OF FINAL SURFACES, SOIL HERBICIDE SHAH BE APPLIED TO THE STONE

1.7 SUBMITTALS

A. PRIOR TO CONSTRUCTION

IF LANDSCAPING IS APPLICABLE TO THE CONTRACT, SUBMIT TWO COPIES OF THE LANDSCAPING PLAN UNDER NURSERY LETTERHEAD. IF A LANDSCAPE ALLOWANCE WAS INCLUDED IN THE CONTRACT, SUBMIT AN ITEMIZED LISTING OF PROPOSED COSTS LINDER NURSERY LETTERHEAD

(REFER TO SITE PLAN FOR LANDSCAPING REQUIREMENT). SUBMIT FOR APPROVAL 1/2 CUBIC FEET OF THE PROPOSED SURFACE COURSE MATERIAL FOLLOWING CONSTRUCTION

MANUFACTURER'S DESCRIPTION OF PRODUCT AND WARRANTY STATEMENT ON SOIL HERBICIDE TREATMENT

2. MANUFACTURER'S DESCRIPTION OF PRODUCT ON GRASS SEED AND FERTILIZER, IF NEEDED.

3. LANDSCAPING WARRANTY STATEMENT, IF REQUIRED.

1.8 WARRANTY

A. IN ADDITION TO THE WARRANTY ON ALL CONSTRUCTION COVERED IN THE CONTRACT DOCUMENTS, THE CONTRACTOR SHALL REPAIR AU DAMAGE OF SURROUNDING PROPERTY CAUSED BY CONSTRUCTION.

B. SOIL HERBICIDE APPLICATION WILL GUARANTEE VEGETATION FREE ROAD AND SITE AREA FOR ONE YEAR FROM THE DATE OF FINAL INSPECTION .
C. DISTURBED AREAS SHALL REFLECT GROWTH OF NEW GRASS COVER PRIOR TO FINAL

D. LANDSCAPING, IF INCLUDED WITHIN THE SCOPE OF THE CONTRACT. SHALL BE GUARANTEED FOR ONE YEAR FROM DATE OF FINAL INSPECTION.

PART 2 - PRODUCTS

A. SUBBASE: GRANULAR MATERIAL MDOT CLASS II OR IIA, MDOT 8.02-3.

AGGREGATE BASE COURSE:

1. F OR BASES TO BE SURFACED WITH CONCRETE OR BITUMINOUS MIXTURES, USE AGGREGATE 22A UNLESS OTHERWISE SPECIFIED. MDOT 3.01.02 AND 8.02.04.

2. FOR BASES TO BE SURFACED WITH AGGREGATE, USE AGGREGATE 6A OR 3-4" CRUSHED CONCRETE (NO REROD). C. AGGREGATE SURFACE COURSE: USE AGGREGATE 21AA WHEN THE AGGREGATE SURFACE

COURSE IS TO BE CONSTRUCTED WITHOUT A BITUMINOUS SURFACE, MDOT 3,08,02 AND 8,02,04.

2.2 EQUIPMENT

A. COMPACTION SHALL BE ACCOMPLISHED BY MECHANICAL MEANS.

1. LARGER AREAS SHALL BE COMPACTED BY SHEEPS FOOT, VIBRATORY OR RUBBER TIRED ROLLERS WEIGHING AT LEAST FIVE TONS.

2. SMALLER AREAS SHALL BE COMPACTED BY POWER-DRIVER, HAND HELD TAMPERS.

PART 3 - EXECUTION

3.1 PREPARATION

A. CLEAR TREES, BRUSH AND DEBRIS FROM SITE AREA AND ACCESS ROAD RIGHT OF WAY (IF REQUIRED).

PRIOR TO OTHER EXCAVATION AND CONSTRUCTION EFFORTS CLEAR SITE OF ORGANIC MATERIAL TO A MINIMUM OF SIX INCHES BELOW ORIGINAL GROUND LEVEL C. UNLESS OTHERWISE INSTRUCTED BY THE OWNER, REMOVE TREES, BRUSH, AND DEBRIS FROM

THE PROPERTY TO AN AUTHORIZED LANDFILL. D. PRIOR TO PLACEMENT OF FILL OR BASE MATERIALS, PROOF ROLL THE SOIL

WHERE UNSTABLE SOIL CONDITIONS ARE ENCOUNTERED. COVER CLEARED AREAS WITH STABILIZER MAT PRIOR TO PLACEMENT OF FILL OR BASE MATERIAL.

A. THE SITE AND TURNAROUND AREA SHAH BE AT THE SUBBASE COURSE ELEVATION PRIOR TO FORMING FOUNDATIONS, GRADE OR FILL THE SITE AND ACCESS ROAD AS REQUIRED SUCH THAT THERE IS AN EVEN DISTRIBUTION OF SPOILS RESULTING FROM FOUNDATION EXCAVATIONS, THE RESULTING GRADE SHAH CORRESPOND WITH SAID SUBBASE COURSE; ELEVATIONS SHALL BE CALCULATED FROM FINISHED GRADES OR SLOPES INDICATED.

B. EXCESS SPOILS, IF ANY, SHALL BE CLEARED FROM JOB SITE AND NOT SPREAD BEYOND THE LIMITS OF OWNER/LEASED PROPERTY UNLESS AUTHORIZED BY PROJECT MANAGER

C. THE ACCESS ROAD SHALL BE BROUGHT TO BASE COURSE ELEVATION PRIOR TO FOUNDATION CONSTRUCTION TO PERMIT USE, COMPACTION SHAH BE PERFORMED DURING CONSTRUCTION OF

D. A VOID CREATING DEPRESSIONS WHERE WATER MAY POND.

E. THE CONTRACT SHAH BE ASSUMED TO INCLUDE GRADING BANKING DITCHING AND UNLESS OTHERWISE INDICATED, COVERING WITH TWO INCHES OF SURFACE COURSE ALL ROADS OR ROUTES UTILIZED FOR ACCESS TO THE OWNER SITE, COMMENCING AT THE POINT OF INTERSECTION WITH THE NEAREST PUBLIC THOROUGHFARE.

WHEN IMPROVING AN EXISTING ACCESS ROAD, THE EXISTING ROAD SHALL BE GRADED TO REMOVE ANY ORGANIC MATTER AND SMOOTH THE SURFACE BEFORE PLACING FILL OR STONE. G. FILL MATERIAL OR STONE SHALL BE PLACED IN SIX-INCH MAXIMUM LIFTS AND COMPACTED AS DESCRIBED, IN SECTION 2.10 PRIOR TO PLACEMENT OF NEXT LIFT.

H. THE FINISH GRADE, INCLUDING TOP SURFACE COURSE, SHALL EXTEND A MINIMUM OF THREE FEET BEYOND THE SITE FENCE AND SHALL COVER THE AREA AS INDICATED.

THICKNESS: CONFORM TO DESIGN CROSS SECTION.

2. CONSTRUCTION METHOD: PLACE IN LAYERS NOT EXCEEDING 15 INCHES LOOSE MEASURE. SPREAD EVENLY AND COMPACT TO NOT LESS THAN NINETY-FIVE PERCENT (95% J MAXIMUM DENSITY ACCORDING TO MICHIGAN SAND CONE TEST. CONFORM CONSTRUCTION TO MDOT 2.11.03. AGGREGATE BASE COURSE:

THICKNESS: COMPACTED IN PLACE IN TWO (2) FOUAL COURSES

CONSTRUCTION METHOD: CONFORM THE PLACING OF AGGREGATE BASE COURSE WITH MOOT

K. AGGREGATE SURFACE COURSE:

THICKNESS: COMPACTED IN PLACE IN TWO (2) EQUAL COURSES.

CONSTRUCTION METHODS; CONFORM CONSTRUCTION OF AN AGGREGATE SURFACE COURSE TO MDOT 3,08,04 THROUGH 3,08,11,

O. RIPRAP SHALL BE APPLIED TO THE SIDE SLOPES OF AU FENCED SITE AREAS, PARKING AREAS AND TO ALL OTHER SLOPES GREATER THAN 2: 1.

RIPRAP SHALL BE APPLIED TO THE SIDE OF DITCHES OR DRAINAGE SWALES.

O. RIPRAP ENTIRE DITCH FOR SIX FEET IN ALL DIRECTIONS AT CUI VERT OPENINGS.

R. SEED, FERTILIZER AND STRAW COVER SHALT BE APPLIED TO ALL OTHER DISTURBED AREAS AND DITCHES, DRAINAGE, SWALES, NOT OTHERWISE RIPRAPPEL S. UNDER NO CIRCUMSTANCES WILL DITCHES, SWALES OR CULVERTS BE PLACED SUCH THAT THEY DIRECT WATER TOWARDS, OR PERMIT STANDING WATER IMMEDIATELY ADJACENT TO THE SITE. IF

OWNER DESIGNS OR ELEVATIONS CONFLICT WITH THIS GUIDANCE THE OWNER SHOULD BE ADVISED T. IF ANY DITCH LIES WITH SLOPES GREATER THAN TEN PERCENT, MOUND DIVERSIONARY HEADWALLS IN THE DITCH AT THE CULVERT ENTRANCES 45 DEGREES OFF THE DITCH LINE, RIPRAP

THE UPSTREAM SIDE OF THE HEADWALL AS WELL AS THE DITCH FOR SIX FEET ABOVE THE CULVERT ENTRANCE. U. SEED AND FERTILIZER SHAH BE APPLIED TO SURFACE CONDITIONS THAT WILL ENCOURAGE

. SAW SEED IN TWO DIRECTIONS IN TWICE THE QUANTITY RECOMMENDED BY THE SEED PRODUCER W. CONTRACTOR IS RESPONSIBLE FOR THE GROWTH OF SEEDED AND LANDSCAPED AREAS BY

ROOTING, RAKE AREAS TO BE SEEDED TO EVEN THE SURFACE AND LOOSEN THE SOIL

WATERING UP TO THE POINT OF RELEASE FROM THE CONTRACT. CONTINUE TO REWORK BARE AREAS UNTIL COMPLETE COVERAGE IS OBTAINED,

DIVISION 3 - CONCRETE

PART 1: GENERAL

1.1 INSPECTIONS

A. LOCAL BUILDING INSPECTION SHALL RECEIVE ADEQUATE NOTIFICATION IN ADVANCE OF

CONCRETE POURS. 1.2 SUMMARY

A. THE WORK INCLUDES ALL CAST-IN-PLACE CONCRETE.

1.3 REFERENCES

ASTM - AMERICAN SOCIETY TESTING MATERIALS, LATEST EDITION. ACI- AMERICAN CONCRETE INSTITUTE LATEST EDITION

MDOT - MICHIGAN DEPARTMENT OF TRANSPORTATION, * STANDARD SPECIFICATIONS FOR CONSTRUCTION® 1990 EDITION.

ACI 318, BUILDING CODE REQUIREMENTS FOR REINFORCED CONCRETE ACI 301. SPECIFICATIONS FOR STRUCTURAL CONCRETE FOR BUILDINGS.

1.4 SUBMITTALS

A. PROPOSED MIX DESIGN PREPARED BY AN APPROVED INDEPENDENT TESTING FIRM FOR EACH CLASS OF CONCRETE. SELECT PROPORTIONS ACCORDING TO ACI301-05, SECTION 3.8, METHOD 1 OR

METHOD 2. SHOP DRAWINGS SHOWING FABRICATION DIMENSIONS AND LOCATIONS FOR PLACING THE REINFORCING STEEL AND ACCESSORIES, DETAILS OF REINFORCEMENT AND ACCESSORIES SHALL BE IN ACCORDANCE VEILTH ACI 315.

C. CERTIFICATIONS FOR THE FOLLOWING:

AGGREGATES ADMIXTURES. 4. REINFORCEMENT

CEMENT.

PART 2 - PRODUCTS

2.1 MATERIALS A. CONCRETE:

CEMENT: ASTM C150 OR ASTM C595 (MAXIMUM FLY ASH CONTENT SHAH BE 20% BY WEIGHT). ALL CEMENT USED IN EXPOSED CONCRETE SHALL BE OF THE SAME BRAND FROM THE SAME MILL 2. COURSE AGGREGATES: ASTM C33.

FINE AGGREGATE: ASTM C33. 4. MIXING WATER: CLEAN FRESH AND POTABLE.

ADMIXTURES: AIR-ENTRAINING: ASTM C260. WATER-REDUCING, RETARDING. AND ACCELERATING: ASTM C494. CALCIUM CHLORIDE WILL NOT BE PERMITTED AS AN ADMIXTURE. POZZOLANIC

ADMIXTURES: ASTM C618, TYPE F, LOSS ON IGNITION LIMITED TO 4 PERCENT (4%). B. REINFORCEMENT: REFER TO TOWER FOUNDATION DESIGN OR TOWER MANUFACTURER FOR TYPE FOR MATERIAL TYPE AND CONFIGURATION OF REINFORCEMENT BARS.

C. CURING COMPOUND, IF NEEDED: ASTM C309

2.15 FIELD QUALITY CONTROL

A. COMPACTION SHALL BE AT LEAST 95% OF MAXIMUM DENSITY AND WITHIN 2% OF OPTIMUM MOISTURE CONTENT IN ACCORDANCE WITH ASTM D-1557. AREAS OF SETTLEMENT SHALL BE EXCAVATED AND REFILLED AT CONTRACTOR'S EXPENSE

B. ALL TREES PLACED IN CONJUNCTION WITH A LANDSCAPE CONTRACT WILL BE WRAPPED, TIED WITH HOSE PROTECTED WIRE AND SECURED TO 2. INCH X 2-INCH X 4-INCH WOODEN STAKES EXTENDING TWO FEET INTO THE GROUND ON FOUR SIDES OF THE TREE.

C. ALL EXPOSED AREAS SHALL BE PROTECTED AGAINST WASHOUTS AND SOIL EROSION, STRAW BALES WIN BE PLACED AT THE INLET APPROACH TO ALL NEW OR EXISTING CULVERTS. WHERE THE SITE OR ROAD AREAS HAVE BEEN ELEVATED IMMEDIATELY ADJACENT TO A RAILLING EROSION CONTROL FABRIC WILL BE STAKED FULL LENGTH IN THE SWALE BETWEEN THE SITE AND THE RAIL BED TO PREVENT CONTAMINATION OF THE RAIL BALLAST.

D. FIELD INSPECTION AND TESTING IS TO BE PERFORMED BY A FIRM APPOINTED AND PAID FOR BY THE OWNER, WHEN ADDITIONAL TESTING OF MATERIALS OR CONCRETE IS NECESSARY BECAUSE OF THEIR FAILURE BY TEST OR INSPECTION TO MEET SPECIFICATION REQUIREMENTS, THE COST OF THE ADDITIONAL TESTING SHALL BE PAID FOR BY THE CONTRACTOR, ADDITIONAL TESTING FOR EARLY FORM REMOVAL SHALL ALSO BE PAID FOR BY THE CONTRACTOR.

E. ACCEPTANCE TESTING: IF INITIAL TESTING INDICATES FAILED OR NON-CONFORMANCE TO SPECIFICATION, PERFORM ADDITIONAL TEST IF FURTHER TESTING VERIFIES NON-CONFORMANCE ADDITIONAL TESTING SHALL BE PAID BY CONTRACTOR. REPLACE NON-CONFORMING MATERIAL AT NO ADDITIONAL COST TO OWNER.

1. AGGREGATES:

A. SAMPLING AND ANALYSIS: MICHIGAN TESTING METHODS, SERIES 100.

B. EXCEPTION: PROVIDE CERTIFICATION OF APPROVED STOCKPILED MATERIAL

2.2 PROPORTIONING CONCRETE

A. PROPORTIONS AND MATERIALS:

PERMISSIBLE CEMENT TYPES: LIP I-A IP-A

MINIMUM CEMENT CONTENT: 5.5 SACKS/CU.YD. FOR 3500 PSI, S.O SACKS/CU.YD. FOR 4000 PSI. COURSE AGGREGATE: MDOT 6A

SAND: MDOT:2NS MAXIMUM WATER-CEMENT RATIO: 5.0 GAL/SACK

ENTRAINED AIR CONTENT: FIVE PERCENT (5%) TO EIGHT PERCENT (8%). MAXIMUM SLUMP:3%-INCH FOR FLOORS AND SLABS ON GRADE, 4 INCHES OTHERWISE (INDIVIDUAL BATCHES MAY BE :1:% INCH AS LONG AS THE AVERAGE OF AU BATCHES IS AT OR BELOW MAXIMUM). MINIMUM COMPRESSIVE STRENGTH, FE' (28 DAY) 4000 PSI FLOORS AND SLABS ON GRADE, ALL

OTHER 3500 PSI. B. ADMIXTURES: APPROVAL OF ENGINEER REQUIRED, USE IN ACCORDANCE WITH THE MANUFACTURER'S INSTRUCTIONS C. IF THE CONTRACTOR INTENDS TO PLACE CONCRETE BY PUMPING, THE MIX DESIGN SHALL BE

PREPARED IN ACCORDANCE WITH THESE SPECIFICATIONS AND THE RECOMMENDATIONS OF ACI 304 2.3 FABRICATING REINFORCEMENT

FABRICATE IN ACCORDANCE WITH APPROVED SHOP DRAWINGS AND AC1315.

REINFORCING SPLICES: CLASS B UNLESS OTHERWISE SHOWN. PART 3 - EXECUTION

3.1 PERFORMANCE

IN ACCORDANCE WITH THE REQUIREMENTS OF ACI301, CHAPTERS 4 THROUGH 13, 17 AND 18. 3.2 CONCRETE WORK FOR DRILLED PIERS

ALL CONCRETE PIERS SHALL BE DRILLED AND POURED ON THE SAME DAY TO PREVENT ANY MIGRATION OF WATER INTO THE HOLE AND TO PREVENT DEBRIS FROM COLLECTING IN THE HOLE.

3.3 FIELD QUALITY CONTROL A. PROVIDE ACCESS TO ALL PORTIONS OF THE WORK AND ANY NECESSARY ASSISTANCE IN OBTAINING AND HANDLING SAMPLES AT THE PROJECT OR OTHER MATERIAL SOURCES. THREE CONCRETE TEST CYLINDERS WILL BE TAKEN FOR EVERY 50 CUBIC YARDS, OR FRACTION THEREOF, FOR EACH CLASS OF CONCRETE PLACE IN ANYONE DAY. ONE ADDITIONAL CYLINDER WILL BE TAKEN DURING COLD WEATHER CONCRETING AND BE CURED ON THE PROJECT SITE UNDER THE SAME CONDITIONS AS THE CONCRETE IT REPRESENTS. ONE SLUMP TEST WILL BE TAKEN FOR EACH SET OF CYLINDERS TAKEN

NOTE: THESE NOTES ARE OF A GENERAL NATURE AND ARE NOT

CROSS-REFERENCE NOTES WITH OTHER SHEETS AND T-MOBILE

SITE-SPECIFIC, SOME NOTES MAY NOT APPLY TO THIS SITE

SCOPE OF WORK TO VERIFY WORK TO BE COMPLETED.

T - Mobile:

1855 GATEWAY BLVD. SUITE 900 CONCORD, CA 94520

L700 CONSTRUCTION

CHECKED BY: APPROVED BY:		RI	
		MB	
#	DATE	DESCRIPTION	INT.
0	5/25/16	90% REVIEW	AA
0	6/24/16	95% REVIEW	AA
0	8/1/16	100% REVIEW	AA
1	8/11/16	FINAL	AA





AMERICAN TOWER CORPORATION 19100 VON KARMAN SUITE 200

I 100 E. WOODFIELD ROAD, SUITE 500 SCHAUMBURG, ILLINOIS 60173 TEL: 847-908-8400

SITE #:

BA90476A

SITE ADDRESS: 6021 LEWIS ROAD VACAVILLE, CA 95687

SHEET NAME:

SHFFT NUMBER:

2016.0249.0003

IRVINE CA 92612

SITE NAME:

ATC LEWIS ROAD

GENERAL NOTES

- INCLUDED WORK OF THIS SECTION GENERALLY INCLUDES PROVISIONS OF LABOR, MATERIALS, EQUIPMENT, ACCESSORIES, NECESSARY FOR INSTALLATION OF MECHANICAL SYSTEMS SHOWN ON THE CONTRACT DRAWINGS AND SPECIFIED IN THE GENERAL NOTES, INTENT OF CONSTRUCTION DOCUMENTS IS TO PROVIDE THE OWNER WITH A COMPLETE AND OPERATING FACILITY, AND ANY MINOR ITEMS OMITTED BUT OBVIOUSLY NECESSARY TO ACCOMPLISH INTENT SHALL BE PROVIDED WHETHER OR NOT SHOWN OR SPECIFIED.

 2. RELATED - THE GENERAL REQUIREMENTS DIVISION OF THE GENERAL NOTES IS HEREBY MADE A
- PART OF THE WORK OF THIS SPECIFICATION. THE REQUIREMENTS OF THIS SPECIFICATION APPLY TO THE WORK OF ALL SECTIONS OF DIVISION 15.
- A. WORK PERFORMED BY OTHERS INCLUDES INSTALLATION OF ELECTRICAL EQUIPMENT, EXCEPT AS NOTED OTHERWISE ON DRAWINGS OR IN SPECIFICATION.
- ELECTRICAL DIVISION 16
- ORDINANCES AND CODES
- A. ALL WORK SHALL BE EXECUTED AND INSPECTED IN ACCORDANCE WITH ALL UNDERWRITER'S. PUBLIC UTILITIES, LOCAL AND STATE CODES AND REGULATIONS APPLICABLE TO THE TRADE AFFECTED. RECOMMENDATIONS OF AFA, NFPA. OSHA AND ASHRAE AND APPLICABLE STATE ENERGY CODE COMPLIANCE SHALL BE RIGIDLY FOLLOWED.
- 3. SHOULD ANY CHANGE IN THE PLANS AND SPECIFICATIONS BE REQUIRED TO COMPLY WITH THESE REGULATIONS, THE CONTRACTOR SHALL NOTIFY THE OWNER BEFORE SUBMITTING HIS BID. AFTER ENTERING INTO CONTRACT WITH THE OWNER. THE CONTRACTOR WILL BE HELD ACCOUNTABLE TO COMPLETE ALL WORK NECESSARY TO MEET THESE REQUIREMENTS AT HIS OWN
- 2. WHERE THE WORK REQUIRED BY THE DRAWINGS AND SPECIFICATIONS IS ABOVE THE STANDARD REQUIRED, IT SHALL BE DONE AS SHOWN OR SPECIFIED.

 4. PERMITS - THE CONTRACTOR SHALL ARRANGE AND PAY FOR ALL PERMITS IN CONNECTION WITH
- HE WORK HEREINAFTER SPECIFIED AND AT COMPLETION OF THE WORK FURNISH THE OWNER WIT
- DRAWINGS THE DRAWINGS INDICATE THE GENERAL ARRANGEMENT OF THE PROPOSED WORK DETAILS OF PROPOSED DEPARTURES DUE TO ACTUAL FIELD CONDITIONS OR OTHER CAUSES SHAH BE PROVIDED FOR. NO EXTRAS WILL BE PAID FOR CORRECTING FAULTY, POORLY ARRANGED, OR
- SITE EXAMINATION THE CONTRACTOR SHALL VISIT THE PREMISES SO AS TO ASCERTAIN THE EXISTING CONDITIONS BEFORE SUBMITTING HIS BID. NO EXTRAS WILL BE ALLOWED FOR HIS LACK OF
- . COMPLETE INSTALLATION THE CONTRACTOR SHALL FURNISH AND INSTALL ALL INCIDENTAL PARTS, VALVES. FITTINGS, PUMPS, CONTROL VALVES AND CONTROL WIRING REQUIRED FOR THE PROPER FUNCTION OF ALL COMPONENT PARTS. THE COMPLETE INSTALLATION SHALL FUNCTION SMOOTHLY AND NOISELESSLY TO THE FULL EXTENT OF THE PLANS AND SPECIFICATIONS. THE CONTRACTOR SHAN COMPLETE HIS INSTALLATION AS RAPIDLY AS GENERAL CONSTRUCTION PERMITS. ALL FILTERS, STRAINERS, AND SAFETY DEVICES SHALL BE PROPERLY INSTALLED BEFORE STARTING EQUIPMENT. THE OWNER SHALL BE LEFT WITH A NEW SET OF FILTERS AT FINAL
- 8. COORDINATION BEFORE ANY EQUIPMENT IS PURCHASED OR FABRICATED AND BEFORE RUNNING ANDIOR FABRICATING ANY LINES OF PIPING OR DUCTWORK, THE MECHANICAL CONTRACTOR AND HIS SUBCONTRACTORS SHALL ASSURE THEMSELVES THAT THEY CAN BE RUN AS CONTEMPLATED, BECAUSE, OF THE SMALL SCALE OF THE DRAWINGS IT IS NOT POSSIBLE TO INDICATE ALL OFFSETS, FITTINGS AND ACCESSORIES THAT MAY BE REQUIRED. THE MECHANICAL CONTRACTOR AND HIS SUBCONTRACTORS SHALL CAREFULLY INVESTIGATE ALL OTHER MECHANICAL. AND ELECTRICAL AND STRUCTURAL DRAWINGS AND FINISH CONDITIONS AFFECTING ALL OF THEIR WORK ACCORDINGLY, FURNISHING SUCH FITTINGS, VALVES, DUCT TRANSITIONS, OFFSETS AND ACCESSORIES AS MAY BE REQUIRED TO MEET SUCH CONDITIONS, AT NO ADDITIONAL
- . TEMPORARY HEAT ARRANGEMENTS FOR USAGE OF SYSTEM FOR TEMPORARY HEAT SHALL BE COORDINATED WITH GENERAL CONTRACTOR, SYSTEM SHAH NOT BE USED FOR TEMPORARY HEAT UNLESS ALL TEMPORARY FILTERS ARE INSTALLED, TEMPORARY FILTERS AND OPERATION OF UNITS SHALL BE PROVIDED BY THE GENERAL CONTRACTOR.
- 10. SUBMITTALS WITHIN 5 DAYS AFTER PROPOSAL ACCEPTANCE THE CONTRACTOR SHALL SUBMIT TO THE OWNER FOR APPROVAL TV/O (2) COPIES OF SHOP DRAWINGS ON EACH ITEM OF EQUIPMENT WHETHER AS SPECIFIED OR SUBSTITUTED, SHOP DRAWINGS SHALL GIVE OVERALL DIMENSIONS. WEIGHTS, METAL GAUGES, MATERIALS, CERTIFIED CAPACITIES, BRAKE HP, MOTOR HP. TUBE DIAMETERS FRICTION DROP AND NAMEPLATE DATA. THE CONTRACTOR SHALL BE RESPONSIBLE FOR CHECKING SHOP DRAWINGS BEFORE SUBMITTING FOR APPROVAL. THE OWNER'S CHECK SHAH BI SENERAL AND DOES NOT RELIEVE THE CONTRACTOR OF FINAL RESPONSIBILITY FOR A COMPLETE JOB TO THE INTENT OF PLANS AND SPECIFICATIONS, AIR CONTROL DIAGRAMS AND EQUIPMENT SHOULD BE ASSEMBLED IN ONE SUBMITTAL
- 11. SUBSTITUTION OF EQUIPMENT A. BIDS SHAH BE BASED ON PROVIDING ALL EQUIPMENT MENTIONED BY BRAND NAME IN PLANS AND SPECIFICATIONS. NO SUBSTITUTIONS SHAH BE CONSIDERED BEFORE BIDDING
- THE CONTRACTOR SHALL ATTACH A LIST OF PROPOSED SUBSTITUTIONS, GIVING THE AMOUNT TO BE ADDED OR DEDUCTED TO CONTRACT PRICE FOR EACH ITEM. COMPLETE ENGINEERING DATA SHALL BE SUBMITTED ON EACH REQUEST FOR SUBSTITUTION ITEM. SUBSTITUTE ITEMS SHALL BE EQUAL OR BETTER THAN ITEMS MENTIONED IN REGARD TO ALL ACCESSORIES, CAPACITIES. DURABILITY AND APPEARANCE. CONTRACTOR SHALL PAY ALL COSTS INCURRED TO MAKE SUBSTITUTE ,ITEMS FIT REQUIRED SPACE WITH MAINTENANCE CLEARANCES - PIPING. SHEET METAL. ELECTRICAL OR BUILDING ALTERATION SHAH BE INCLUDED IN SAID COSTS
- . ALL STANDARD ACCESSORIES AS WELL AS SPECIFIED EXTRAS SHALL BE PROVIDED WITH EQUIPMENT.
- 12. GUARANTEE ALL MATERIAL AND WORKMANSHIP INSTALLED AND/OR FURNISHED UNDER THIS TION OF WORK SHALL BE GUARANTEED AGAINST DEFECTS FOR A PERIOD OF ONE YEAR FROM DATE OF ACCEPTANCE BY OWNER. ANY DEFECTS OR FAULTY WORKMANSHIP SHALL BE THE CONTRACTOR'S RESPONSIBILITY AND SHALL BE CORRECTED ENTIRELY AT HIS EXPENSE.

PART 2 - PRODUCTS

- APPROVED MANUFACTURERS APPROVAL BY NAME LISTED IN THIS SPECIFICATION DOES NOT IMPLY THAT THE MANUFACTURER STANDARD PRODUCT MEETS THE INTENT OF THE DRAWINGS AND SPECIFICATION, IT IS THE CONTRACTORS RESPONSIBILITY TO PROVIDE ALL NECESSARY ALTERATIONS, MATERIALS, LABOR, ETC., AS APPROVED BY THE OWNER TO MEET THE FULL INTENT OF THE DRAWINGS AND SPECIFICATIONS. THIS IS TO INCLUDE, BUT NOT NECESSARILY BE LIMITED TO ELECTRICAL STRUCTURAL MECHANICAL AND ARCHITECTURAL ALTERATIONS AND REVISIONS
- 2. MATERIALS MATERIALS THROUGHOUT SHALL BE NEW AND OF THE BEST GRADES SPECIFIED. THEY SHALL BE STANDARD CATALOG ITEMS AND MANUFACTURED BY NATIONALLY KNOWN MANUFACTURERS OF THE ITEMS SPECIFIED, CONTRACTOR SHALL RECEIVE AND BE RESPONSIBLE FOR ALL OWNER FURNISHED EQUIPMENT AND PROVIDE ROUGH-IN AND FINAL CONNECTIONS FOR ALL MECHANICAL EQUIPMENT FURNISHED UNDER THIS CONTRACT OR BY OTHERS, THE CONTRACTORS SHALL PROVIDE A SUITABLE SHED FOR THE STORAGE OF ALL MATERIALS DURING PROGRESS OF THE JOB.

 3. SOLDER-ALL SOLDER USED ON SWEAT FITTINGS SHALL BE 95-5 HARD SOLDER UNLESS BRAZING
- OR SILVER SOLDER IS SPECIFIED. ALL BURIED COPPER PIPING SHALL BE SILVER SOLDERED.

 4. FLOOR, CEILING PLATES, FLANGES PROVIDE TIGHT FITTING FLOOR AND CEILING PLATES ON PIPES PASSING THROUGH WALLS, CEILINGS, FLOORS, NICKEL OR CHROME PLATE IN FINISHED
- AREAS. PROVIDE WALL AND CEILING FLANGES FOR DUCTS IN FINISHED AREAS.

 5. PIPE HANGERS, SUPPORTS PROVIDE HANGERS, SUPPORTS, BRACES BY GRINNELL, FEE AND MASON, GRABLER, ELCEN, UNISTRUT, BASIN ENGINEERS, INC. TO PREVENT UNDUE STRAIN STRESSES, NOISE, VIBRATION,

PART 3 - EXECUTION

WORKMANSHIP

- A. WORK THROUGHOUT SHALL BE PERFORMED BY MEN SKILLED IN THE INSTALLATION OF THE VARIOUS TRADES OF THE WORK HEREIN SPECIFIED.
- 3. AFT PIPING AND DUCTWORK SHALL BE RUN CONCEALED IN FINISHED AREAS EXCEPT WHERE NOTED OTHERWISE OR AS CHROME PLATED PLUMBING FIXTURE CONNECTIONS.
- 2. CURBS, BASES, SUPPORTS MAJOR CURBS, OPENINGS, AND EQUIPMENT SUPPORTS WILL BE PROVIDED UNDER THE GENERAL SECTION OF THIS CONTRACT ONLY WHERE SHOWN ON ENGINEERING OR STRUCTURAL PLANS, ALL OTHER SUPPORTS, ANCHORS, AND BASES SHALL BE PROVIDED BY MECHANICAL CONTRACTOR FOR ALL MECHANICAL EQUIPMENT EQUIPMENT SHALL BE SUPPORTED PER MANUFACTURER'S WRITTEN RECOMMENDATIONS FOR NOISE-FREE INSTALLATION. 3. REMOVAL OF EXISTING WORK - ALL EXISTING MECHANICAL FOLIPMENT PIPING FTC. REMOVED
- BY THE CONTRACTOR SHALT BE THE PROPERTY OF THE BUILDING, SUCH ITEMS WIII BE DISPOSED OF AT THE BUILDING OWNER'S DIRECTION.
- 4. REMOVAL OF RUBBISH ON COMPLETION OF HIS WORK, THE CONTRACTOR SHALT REMOVE ALL OF HIS TOOLS, SCAFFOLDING, DEBRIS, ETC., FROM THE GROUNDS AND LEAVE THE PREMISES PERFECTLY CLEAN.
- OPERATING AND MAINTENANCE INSTRUCTIONS UPON COMPLETION, THE CONTRACTORS SHALL MAKE UP A SET OF OPERATING AND MAINTENANCE INSTRUCTIONS COVERING ALL MECHANICAL EQUIPMENT WITH MOVING OR MOVEABLE PARTS INCLUDING GENERAL OPERATING OR HEATING. PLUMBING AND COOLING SYSTEMS AND SHALL GIVE THE OWNER FOUR (4) COPIES OF THESE NSTRUCTIONS, MANUFACTURER'S PRINTED OPERATIONS AND MAINTENANCE INSTRUCTIONS SHALL ALSO BE PROVIDED FOR EACH PIECE OF EQUIPMENT.
- A. NAME, ADDRESS, AND TELEPHONE NUMBER OF PARTY TO BE CONTACTED FOR 24 HOUR SERVICE FOR EACH ITEM OF EQUIPMENT
- B. STARTING, STOPPING. LUBRICATION, AND ADJUSTMENT SHALL BE CLEARLY INDICATED FOR EACH PIECE OF EQUIPMENT.
- C. PREPARE 8-112"X11" BLUEPRINTS WITH BINDING EDGE OF APPROPRIATE SCALE TO INDICATE ALL EQUIPMENT, RESPECTIVE SWITCHES, AND VALVE LOCATIONS. BIND IN INSTRUCTION BOOK.

DIVISION 5 - FENCE PART 1 - GENERAL

3.1 WORK INCLUDED

- A. REFER TO THE SITE PLANS FOR SIZE AND LOCATION OF FENCE AND GATES TO BE INSTALLED.
- 3.2 RELATED WORK
- A. COORDINATE FENCE GROUNDING WITH ELECTRICAL CONTRACTOR.
- B. REFER TO FENCE DETAIL PLAN CONCRETE FOR SPECIFICATION OF CONCRETE AND GROUT C. REFER TO FENCE DETAIL PLAN FOR APPLICABLE LOCATIONS OF ACCESS ROAD GATES.

A. A SECURITY FENCE IS PROVIDED IN ORDER TO INHIBIT UNAUTHORIZED ACCESS TO THE SITE

3.4 QUALITY ASSURANCE

REFER TO FENCE DETAIL PLAN.

3.5 SEQUENCING

A. IF THE SITE AREA HAS BEEN BROUGHT UP TO SURFACE COURSE, ELEVATION PRIOR TO FENCE CONSTRUCTION. FENCE POST EXCAVATION SPOILS MUST BE CONTROLLED TO PRECLUDE CONTAMINATION OF SURFACE COURSE

3.6 SUBMITTALS

- A. MANUFACTURER'S DESCRIPTIVE LITERATURE.
- B. CERTIFICATE OF COMPLIANCE THAT SPECIFICATIONS HAVE BEEN MET.

3.7 FENCE MATERIAL

REFER TO FENCE DETAIL PLAN.

DIVISION 7 - ANTENNA SYSTEM PART 1 - GENERAL

1.1 WORK INCLUDED

- A. ERECT FURNISHED TOWER AS INDICATED IN THE DRAWINGS
- . INSTALL ANTENNAS AS INDICATED ON DRAWINGS AND OWNER SPECIFICATIONS.
- INSTALL ANTENNA PLATFORM AS INDICATED ON DRAW
- D. INSTALL FURNISHED GALVANIZED STEEL WAVEGUIDE LADDER
- E. INSTALL WAVEGUIDE BRIDGE AS INDICATED ON DRAWINGS.
- INSTALL COAX CABLE, CONNECTORS, JUMPERS, GROUNDING KITS AS INDICATED IN DRAWINGS.
- G. SWEEP TEST RESULT.

1.2 REQUIREMENTS OF REGULATORY AGENCIES

- A. FURNISH U.L. LISTED EQUIPMENT WERE SUCH LABEL IS AVAILABLE, INSTALL IN CONFORMANCE WITH U.L. STANDARDS WHERE APPLICABLE.
- B. INSTALL ANTENNA, ANTENNA CABLES, GROUNDING SYSTEM IN ACCORDANCE WITH DRAWINGS AND SPECIFICATION IN EFFECT AT PROJECT LOCATION AND RECOMMENDATIONS OF STATE AND LOCAL BUILDING CODES, SPECIAL CODES HAVING JURISDICTION OVER SPECIFIC PORTIONS OF WORK, THIS INCLUDES, BUT IS NOT LIMITED TO, THE FOLLOWING:
- 1. EIA ELECTRICAL INDUSTRIES ASSOCIATION RE -222, STRUCTURAL STANDARDS FOR STEEL ANTENNA TOWERS AND ANTENNA SUPPORTING STRUCTURES.
- FAA FEDERAL AVIATION ADMINISTRATION ADVISORY CIRCULAR AC 70F7460-IH, OBSTRUCTION MARKING AND LIGHTING.
- 3. FCC FEDERAL COMMUNICATIONS COMMISSION RULES AND REGULATIONS FORM 715 "OBSTRUCTION MARKING AND LIGHTING SPECIFICATIONS FOR ANTENNA STRUCTURES", AND FORM 715A "HIGH INTENSITY OBSTRUCTION LIGHTING SPECIFICATION FOR ANTENNA STRUCTURES" DISC - AMERICAN INSTITUTE OF STEEL CONSTRUCTION SPECIFICATIONS FOR STRUCTURAL
- JOINTS USING ASST. A325 OR A490 BOILS. NECK - NATIONAL ELECTRICAL CODE - ON TOWER LIGHTING KITS.
- 6. UL UNDERWRITER'S LABORATORIES APPROVED.
- IN ALL CASES PART 77 OR THE FAA RULES AND PARTS 17 AND 22 OF THE FCC RULES ARE APPLICABLE AND IN THE EVENT OF CONFLICT, SUPERSEDE ANY OTHER STANDARDS OR SPECIFICATIONS, 1990 LIFE SAFETY CODE NAPA - 101.

DIVISION 16 - GENERAL ELECTRIC

PART 1 - GENERAL ELECTRICAL PROVISION

- 1. SUBMITTAL OF BID INDICATES CONTRACTOR IS COGNIZANT OF ALL JOB SITE CONDITIONS AND WORK TO BE PERFORMED UNDER THIS CONTRACT.
- 2. CONTRACTOR SHALL PERFORM ALL VERIFICATION, OBSERVATIONS, TESTS, AND EXAMINATION WORK PRIOR TO THE ORDERING OF THE ELECTRICAL EQUIPMENT AND THE ACTUAL CONSTRUCTION. CONTRACTOR SHALL ISSUE A WRITTEN NOTICE OF ALL FINDINGS TO THE ARCHITECT LISTING ALL MALFUNCTIONS, FAULTY EQUIPMENT AND DISCREPANCIES.
- HEIGHTS SHAH BE VERIFIED WITH OWNER PRIOR TO INSTALLATION.
 THESE PLANS ARE DIAGRAMMATIC ONLY.
- ELECTRICAL SERVICE 120/240 V.A.C. SINGLE PHASE 3-WIRE 100 AMP SERVICE.
 CONTRACTOR SHALL PROVIDE ALF LABOR, MATERIALS, INSURANCE, EQUIPMENT, INSTALLATION,
- CONSTRUCTION TOOLS. TRANSPORTATION, ETC. FOR A COMPLETE AND PROPERLY OPERATIVE SYSTEM ENERGIZED THROUGHOUT AND AS INDICATED ON DRAWINGS, AS SPECIFIED HEREIN ND/OR AS OTHERWISE REQUIRED.
- 7. CONTRACTOR SHALL CARRY OUT ALL WORK IN ACCORDANCE WITH ALL GOVERNING STATE, COUNTY, AND LOCAL CODES AND O.S.H.A.

 8. CONTRACTOR SHALL SECURE ALL NECESSARY BUILDING PERMITS AND PAY ALL REQUIRED FEES
- COMPLETE JOB SHALL BE GUARANTEED BY THE CONTRACTOR FOR A PERIOD OF ONE (1) YEAR AFTER THE DATE OF JOB ACCEPTANCE BY OWNER, ANY WORK MATERIAL OR FOLIPMENT FOLIND TO BE FAULTY DURING THAT PERIOD SHALL BE CORRECTED AT ONCE, UPON WRITTEN NOTIFICATION, AT THE EXPENSE OF THE CONTRACTOR.
- 10. PROVIDE PROJECT MANAGER WITH ONE SET OF COMPLETE ELECTRICAL "AS INSTALLED" AWINGS AT THE COMPLETION OF THE JOB, SHOWING ACTUAL DIMENSIONS, ROUTINGS AND CIRCUITS.

OR ALL DEBRIS RESULTING FROM WORK AND LEAVE WORK IN A COMPLETE AND UNDAMAGED

11. THE ENTIRE ELECTRICAL INSTALLATION SHALL BE GROUNDED AS REQUIRED BY AH APPLICABLE 12. UPON COMPLETION OF WORK, CONDUCT CONTINUITY, SHORT CIRCUIT AND FALL POTENTIAL GROUND TESTS FOR APPROVAL, SUBMIT TEST REPORTS TO PROJECT MANAGER, CLEAN PREMISES

- PART 2 PRODUCTS

 A. ALL MATERIALS AND EQUIPMENT SHALL BE NEW AND IN PERFECT CONDITION WHEN INSTALLED

 A. ALL MATERIALS AND EQUIPMENT SHALL BE NEW AND IN PERFECT CONDITION WHEN INSTALLED

 THE CAME LIAMILEACTH DEEP THROUGHOUT FOR EACH AND SHALL BE OF THE BEST GRADE AND OF THE SAME MANUFACTURER THROUGHOUT FOR EACH CLASS OR GROUP OF EQUIPMENT MATERIAL SHALL BE LISTED "J" WHERE SUBJECT TO SUCH APPROVAL, MATERIALS SHALL MEET WITH APPROVAL OF THE DIVISION OF INDUSTRIAL SAFETY AND ALL GOVERNING BODIES HAVING JURISDICTION, MATERIALS SHALL BE MANUFACTURED IN ACCORDANCE WITH APPLICABLE STANDARDS ESTABLISHED BY ANSI, NEMA AND NBFU.
- B. ALL CONDUIT ONLY (C. 0.) SHALL HAVE A PULL WIRE OR ROPE. C. ALL CONDUCTORS SHALL BE COPPER.
- D. ALL CIRCUIT BREAKERS, FUSES AND ELECTRICAL EQUIPMENT SHALL HAVE AN INTERRUPTING
- SHORT CIRCUIT TO WHICH THEY MAY BE SUBJECTED, AND A MINIMUM OF 1 0,000 A.I.C.
 E. WIRE AND CABLE CONDUCTORS SHALL BE COPPER 12 AWG MINIMUM UNLESS SPECIFICALLY NOTED OTHERWISE ON DRAWINGS
- F. GROUNDING CONDUCTORS SHAH BE SOLID TINNED COPPER AND ANNEALED +2.
- METER SOCKET AMPERES, VOLTAGE, NUMBER OF PHASES SHALL BE AS NOTED ON THE DRAWINGS, MANUFACTURED BY SQUARE 0 COMPANY OR APPROVED EQUAL.
- I. ALL MATERIAL SHALL BE U.L. LISTED. ALL UNDERGROUND CONDUIT SHALL BE PVC SCHEDULE 40 (UNLESS NOTED OTHERWISE) AT A MINIMUM DEPTH OF 24" BELOW GRADE.
- 1. ALL GROUND CABLE SHALL BE STANDARD TND SOLID BARE COPPER PLATE AND OF SIZE
- INDICATED ON DRAWINGS.

 2. WHEN THE DIRECTION OF THE CONDUCTOR MUST CHANGE IT SHALL BE DONE GRADUALLY, THE CURVATURE OF THE TURN SHALL BE DONE IN ACCORDANCE WITH THE FOLLOWING TABLE

GROUNDING CONDUCTOR SIZE MIN BENDING RADIUS TO INSIDE EDGE: NO.6 AWG. TO NO. 4 AWG NO. 2/0 AWG. TO 750 MCRN

PART 3 - UNDERGROUND ELECTRICAL SERVICE

- A. COORDINATE THE ELECTRICAL SERVICE WITH THE UTILITY COMPANY.
- B. CONTRACTOR TO COORDINATE WITH UTILITY COMPANY CONNECTION OF TEMPORARY AND PERMANENT POWER TO THE SITE. THE TEMPORARY POWER AND ALL HOOKUP COSTS TO BE PAID BY CONTRACTOR.

NO RESTRICTIONS

C. THE SERVICE SHALL BE INSTALLED IN ACCORDANCE WITH ALL APPLICABLE CODES AND STANDARDS TO BE ACCEPTABLE TO THE GOVERNING AUTHORITIES EXERCISING LEGAL JURISDICTION OVER ELECTRICAL INSTALLATIONS.

PART 4 - GROUNDING CONNECTIONS

- EXTERNAL CONNECTIONS:
- ALL EXTERNAL GROUNDING CONNECTIONS SHALL BE MADE BY THE "CADWELD" PROCESS CONNECTIONS SHALL INCLUDE ALL CABLE TO CABLE SPLICES, TEES, XS, ETC. AIL CABLE TO GROUND RODS, GROUND ROD SPLICES AND LIGHTNING PROTECTION SYSTEM AS INDICATED, ALL MATERIALS USED (MOLDS, WELDING, METAL, TOOTS, ETC.) SHALL BE BY "CADWELD" AND INSTALLED PER MANUFACTURER'S RECOMMENDATION AND PROCEDURES.
- 2. ALL INTERIOR GROUNDING AND BONDING CONDUCTORS SHALL BE CONNECTED BY TWO HOLES CRIMP TYPE (COMPRESSION) CONNECTIONS (EXCEPT FOR THE ACEG AND GROUND ROD) MECHANICAL CONNECTIONS, FITTING OR CONNECTIONS THAT DEPEND SOLELY ON SOLDER SHALL NOT BE USED.
- ALL GROUND RODS SHALL BE 5/8" DIAMETER X 10'-O" LONG "COPPERWELD" OR APPROVED EQUAL OF THE NUMBER AND AT LOCATIONS INDICATED. GROUND RODS SHALL BE DRIVEN FULL LENGTH VERTICAL IN UNDISTURBED EARTH, ALL GROUND RODS TO BE 10' APART UNLESS OTHERWISE
- C. GROUND BARS: ALL GROUND BARS SHALL BE 1/4" THICK BARE COPPER PLATE AND OF SIZE INDICATED ON

D. GROUND RING

- THE GROUND RING ENCIRCLING THE BUILDING SHALL BE MINIMUM SIZE OF NO. 2 AWG BARE COPPER CONDUCTOR IN DIRECT CONTACT WITH THE EARTH AT A DEPTH OF NOT LESS THAN 42 INCHES (MIN) CONDUCTOR BENDS SHALL HAVE A MINIMUM RADIUS OF 8 INCHES. ALL EXTERNAL GROUND RINGS SHALL BE JOINED TOGETHER AND ALL CONNECTIONS SHALL BE
- 'CADWELD', NO LUGS OR CLAMPS WILL BE ACCEPTED. FENCE/GATE ALL SECTIONS OF FENCE AND GATE SHAH BE GROUNDED AS INDICATED ON DRAWINGS, GROUND EACH GATE POST AND CORNER POST, ALL OTHER CONNECTIONS FOR THE GROUND GRID SYSTEM SHALL BE MADE BY THE "CADWELD" PROCESS, AND INSTALLED PER MANUFACTURER'S RECOMMENDATIONS AND PROCEDURES.
- F. GROUND TEST PIT A GROUND TEST PIT SHALL CONSIST OF 6" DIAMETER SCH 40 PVC L'IITH 6" P. GROUND LEST PIT A GROUND LEST PIT STALL CONSIST OF & DIAMETER SCHOOL PAGE, CLEANOUT FULGE ACLEANOUT ADAPTER FITTING, PLUG THREADS SHALL BE COATED WITH ANTI-SEIZE LUBRICANT PRIOR TO INSTALLATION. 6" PVC WILL BE 18" LONG, BURIED 12" UNDERGROUND WITH 61" ABOVE FINISHED GRADE. TOP OF GROUND ROD CADWELDED TO GROUND RING WIN BE 12" FROM TOP OF CLEANOUT ADAPTER.

PART 5 - ASTM FALL POTENTIAL TESTS

- A. GROUND TESTS SHAH BE PERFORMED AS INDICATED ON DRAWINGS, A BIDDLE GROUND OHM METER OR THE METHOD OF USING TWO AUXILIARY GROUND RODS (AS DESCRIBED IN LE.E.E. STANDARD NO. 81-1983, PART 1) MAY BE USED. THE LEFF, METHOD REQUIRES THE USE OF AN A C TEST CURRENT THE AUXILIARY TEST RODS MUST BE SUFFICIENTLY FAR AWAY FROM THE ROD UNDER TEST SO THAT THE REGIONS IN WHICH THEIR RESISTANCE IS LOCALIZED DO NOT OVERLAP.
- B. CONTRACTOR TO CONDUCT GROUND RESISTANCE TEST IN THE FORMAT AS FOLLOWS
- EQUIPMENT BUILDING
- A. FIRST TEST SHALL BE WITH FOUR GROUND RODS INSTALLED, ONE AT EACH CORNER OF THE BUILDING BUT NOT CONNECTED TO THE MAIN GROUNDING BUS. FURNISH WIRE TO CONNECT TEMPORARY CLAMP) ALL FOUR GROUND RODS TOGETHER TO MAKE A SYSTEM TEST AFTER EACH ROD IS INDIVIDUALLY TESTED. IF ANY INDIVIDUAL ROD TESTS 25 OHMS OR MORE, THE ELECTRICAL CONTRACTOR AND OWNER'S REPRESENTATIVE SHOULD BE NOTIFIED SO THAT THE ROD CAN BE DRIVEN DEEPER UNTIL ALL FOUR RODS HAVE A RESISTANCE OF 10 OHMS OR LESS ON A DR
- B. SECOND TEST SHALL BE WITH THE GROUND RODS CONNECTED WITH DRY SOIL AND WHEN NO STANDING WATER HAS BEEN PRESENT FOR THE PAST TEN DAYS. THE MAXIMUM ALLOWABLE READING IS 5 OHMS TO GROUND. IF THE RESISTANCE OF THE ENTIRE SYSTEM EXCEEDS 5 OHMS. THE ELECTRICAL CONTRACTOR AND OWNER'S REPRESENTATIVE SHOULD BE NOTIFIED SO THAT EITHER ADDITIONAL AND/OR DEEPER RODS CAN BE INSTALLED.
- 2. TOWER
- FIRST TEST SHALL BE WITH NINE (9) GROUND RODS INSTALLED (MIN.) EQUALLY SPACED AROUND THE TOWER FOUNDATION, BUT NOT CONNECTED TO THE EQUIPMENT BUILDING EXTERNAL GROUND RING, FURNISH WIRE TO CONNECT (TEMPORARY CLAMP) ALL THREE GROUND RODS. TOGETHER TO MAKE A SYSTEM TEST AFTER EACH ROD IS OHMS OR MORE, THE ELECTRICAL ENGINEER AND THE OWNER'S REPRESENTATIVE SHOULD BE NOTIFIED SO THAT THE ROD CAN BE DRIVEN DEEPER UNTIL ALL THREE RODS HAVE A RESISTANCE OF 10 OHMS OR LESS ON A DRY DAY. B. SECOND TEST - SHALL BE WITH THE GROUNDS CONNECTED, WITH DRY SOIL AND WHEN NO STANDING WATER HAS BEEN PRESENT FOR THE PAST TEN DAYS. THE MAXIMUM ALLOWARD F READING IS 5 OHMS TO GROUND. IF THE RESISTANCE OF THE ENTIRE SYSTEM EXCEEDS 5 OHMS THE ELECTRICAL CONTRACTOR AND OWNER'S REPRESENTATIVE SHOULD BE NOTIFIED SO THAT EITHER ADDITIONAL AND/OR DEEPER RODS CAN BE INSTALLED.
- AFTER THE EQUIPMENT BUILDING AND TOWER GROUND RESISTANCE TEST IS COMPLETED, ELECTRICAL CONTRACTOR SHALL TIE EQUIPMENT BUILDING EXTERNAL GROUND RING TOGETHER AFTER FIRST AND SECOND TEST, AFT CONNECTIONS SHALL BE "CADWELD", NO LUGS OR CLAMPS WILL BE ACCEPTED
- B. AFTER ALL THE EXTERNAL GROUND RINGS ARE TIED TOGETHER BUT BEFORE THE EQUIPMENT BUILDING IS TIED DOWN, A MEGGER CHECK OF THE GROUND SYSTEM SHOULD BE DONE. THE MAXIMUM ALLOWABLE READING IS 5 OHMS TO GROUND.

C. GROUND RESISTANCE TEST REPORT

UPON COMPLETION OF THE TESTING FOR EACH SITE, CONTRACTOR SHAH SUBMIT A TEST REPORT SHOWING RESISTANCE IN OHMS WITH AUXILIARY POTENTIAL ELECTRODES AT 5-FOOT AND 10-FOOT INTERVALS UNTIL THE AVERAGE RESISTANCE STARTS INCREASING; 10-15 PHOTOS MUST BE TAKEN TO PROOF ENTIRE EXTERNAL GROUND RING SYSTEM BEFORE BACKFILL OR PROJECT MANAGER MUST BE NOTIFIED NO LESS THAN 48 HOURS IN ADVANCE OF BACKFILL. TESTING SHALL BE COMPLETED BY GENERAL CONTRACTOR AND TWO (2) SETS OF TEST DOCUMENTS ARE TO BE BOUND AND SUBMITTED WITHIN ONE WEEK OF WORK OF COMPLETION.

1855 GATEWAY BLVD. SUITE 900 CONCORD, CA 94520

L700 CONSTRUCTION

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	APF	PROVED BY:	MB	
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	0	6/24/16	95% REVIEW	AA
	0	8/1/16	100% REVIEW	AA
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AMERICAN TOWER CORPORATION 19100 VON KARMAN SUITE 200 IRVINE CA 92612

1100 E. WOODFIELD ROAD, SUITE 500 SCHAUMBURG, ILLINOIS 60173 TEL: 847-908-8400

SITE #:

BA90476A

SITE NAME:

ATC LEWIS ROAD

SITE ADDRESS: 6021 LEWIS ROAD VACAVILLE, CA 95687

SHEET NAME:


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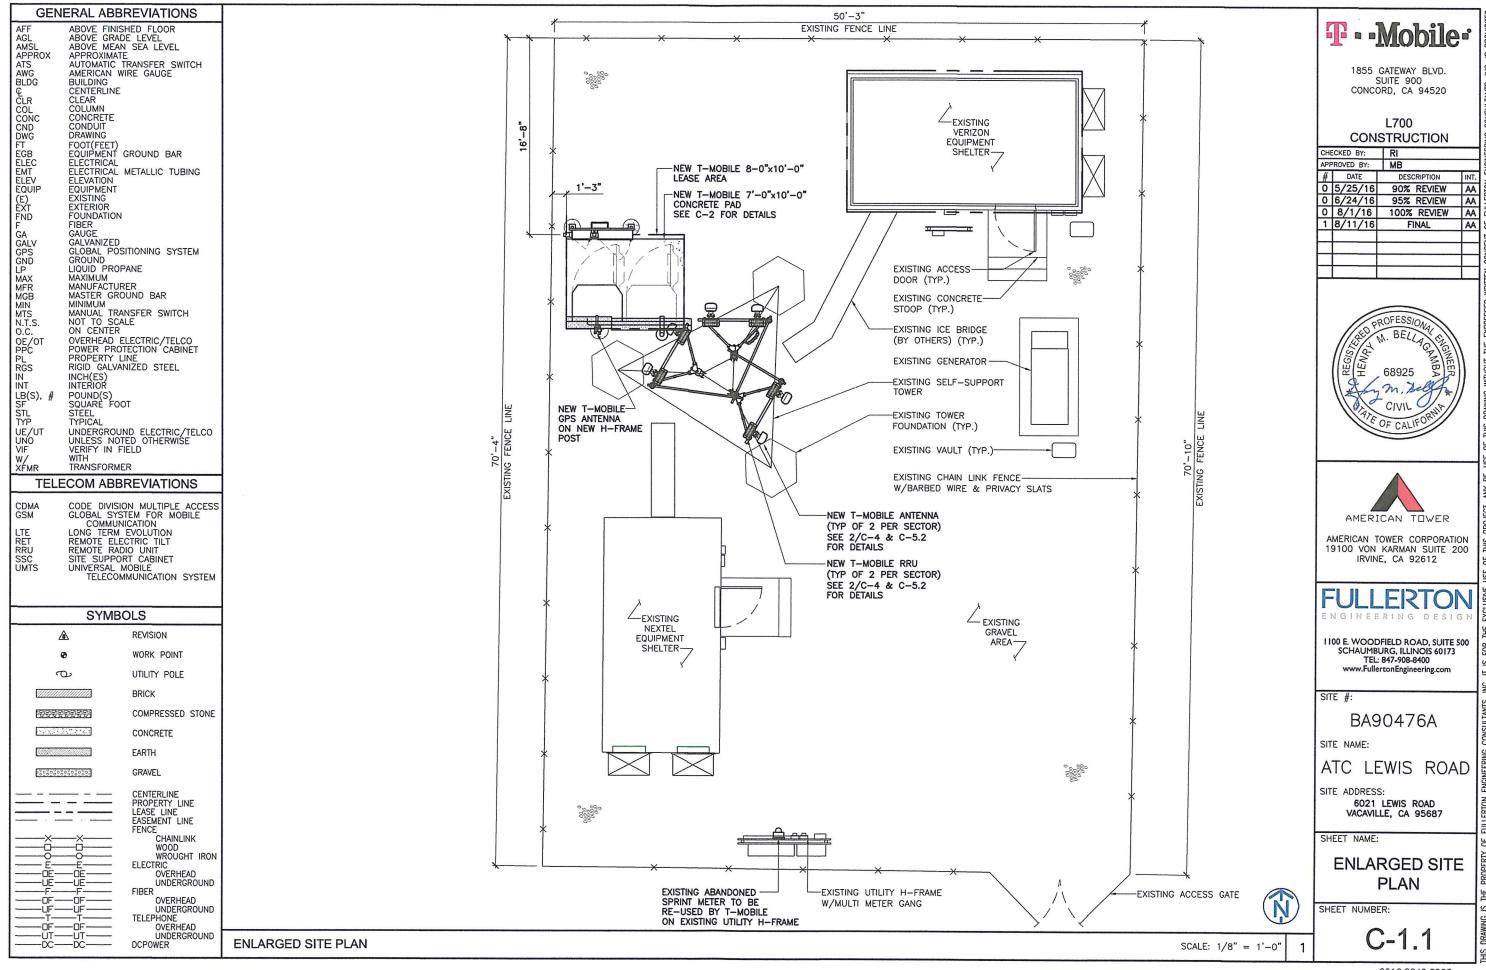
SITE-SPECIFIC, SOME NOTES MAY NOT APPLY TO THIS SITE CROSS-REFERENCE NOTES WITH OTHER SHEETS AND T-MOBILE SCOPE OF WORK TO VERIFY WORK TO BE COMPLETED.


NOTE: THESE NOTES ARE OF A GENERAL NATURE AND ARE NOT

2016.0249.0003

GENERAL NOTES



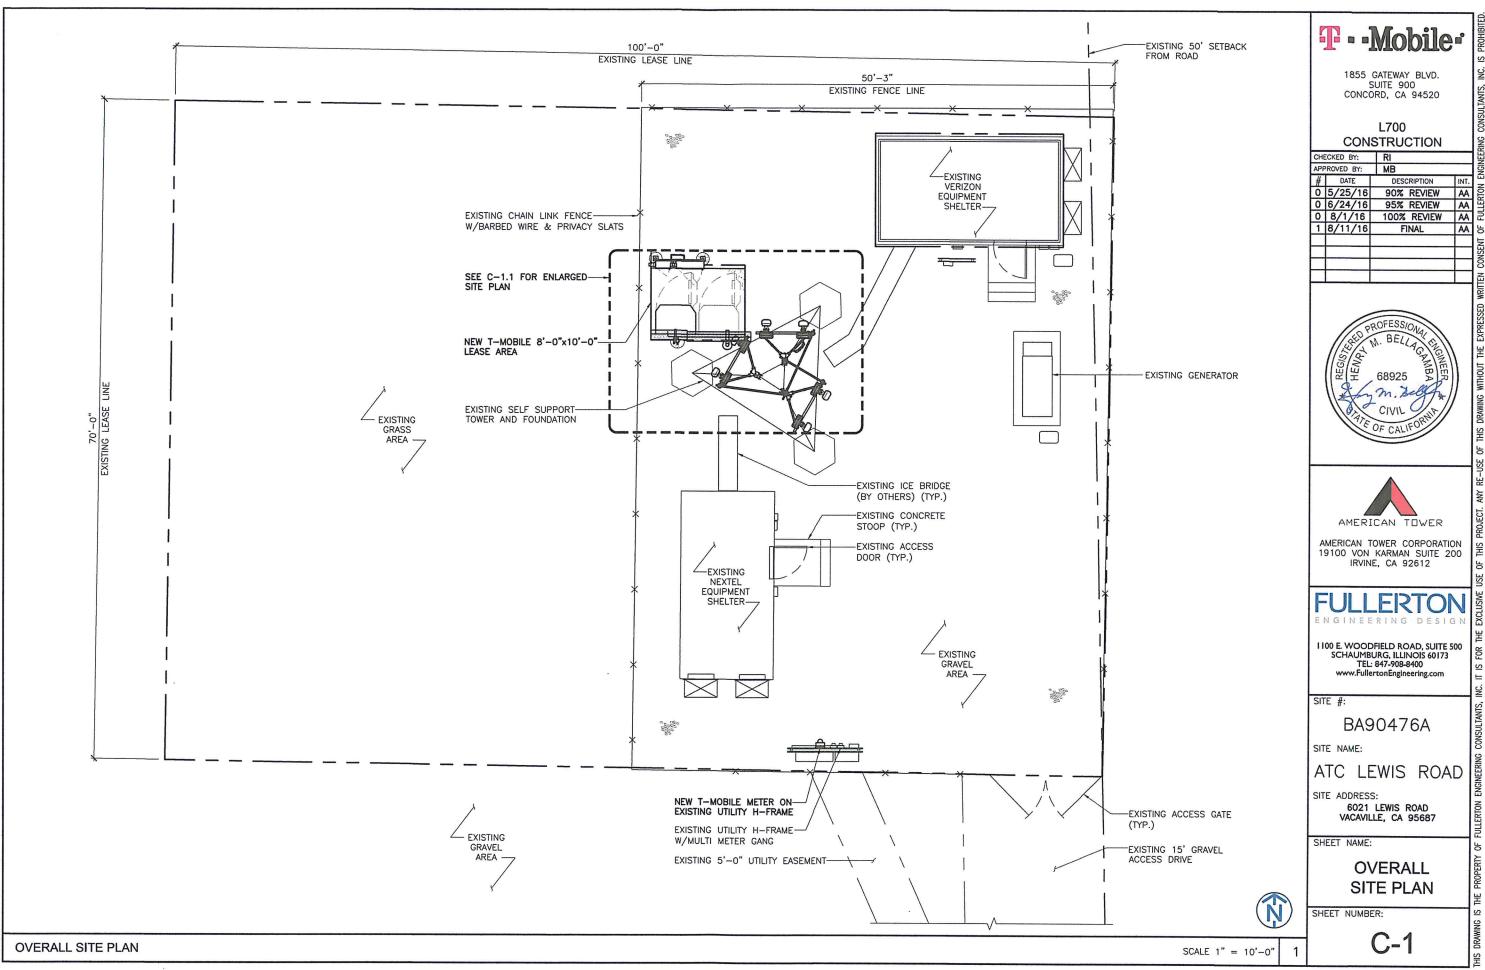

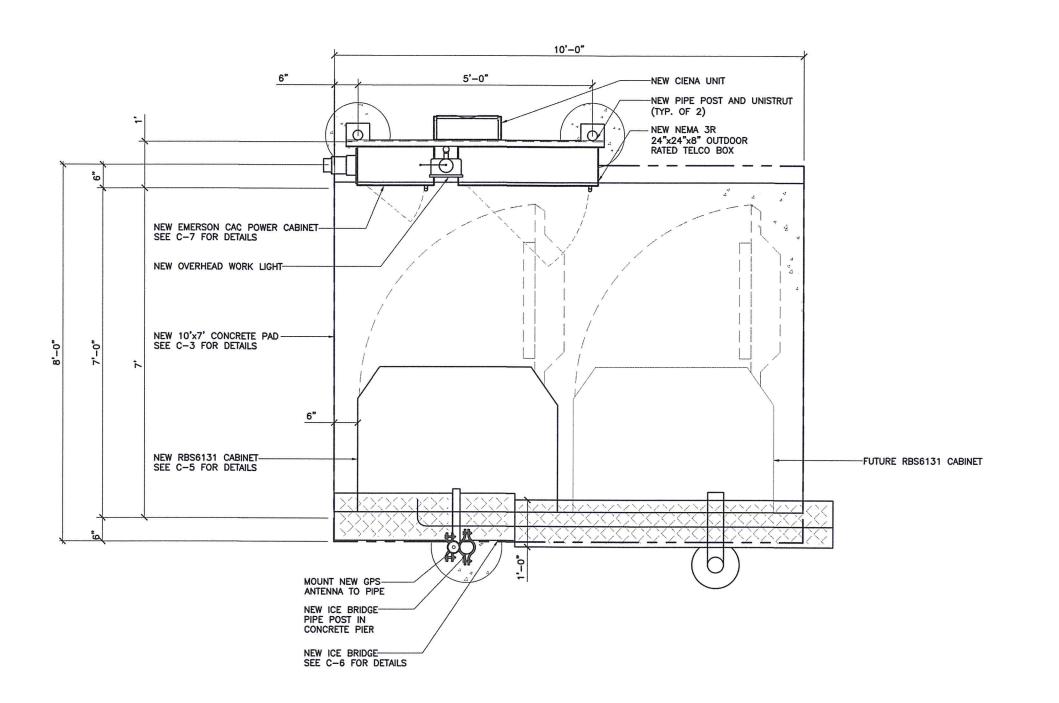



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L700 CONSTRUCTION

APPROVED BY: MB # DATE DESCRIPTION 0 5/25/16 90% REVIEW 0 6/24/16 95% REVIEW 0 8/1/16 100% REVIEW	REVIEW AA REVIEW AA REVIEW AA
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6021 LEWIS ROAD VACAVILLE, CA 95687


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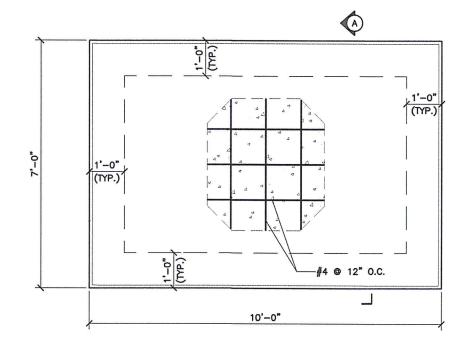
EQUIPMENT PLAN


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SECTION A:

CONCRETE NOTES:

1. MEET OR EXCEED THE FOLLOWING CODES AND STANDARDS CEMENT.. ..ASTM C 150 (TYPE I) DESIGN. CONSTRUCTION. ..ACI 301-10

..CRSI MANUAL OF STANDARD DETAILING.. PRACTICE

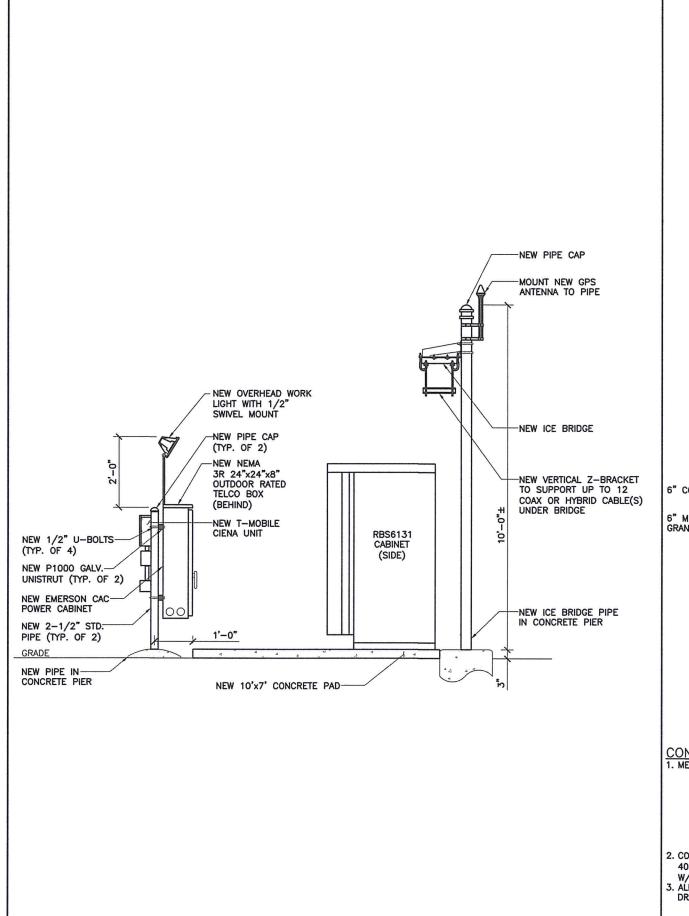MIXING.. AIR ENTRAINMENT.....ASTM C233 REINF. STEEL.

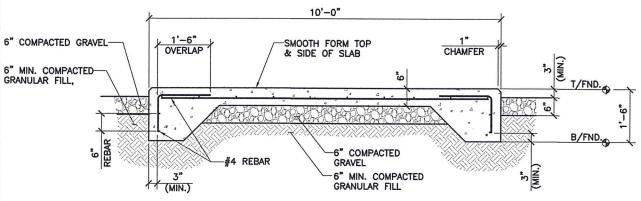...ASTM A 615 GRADE 60, DEFORMED 2. CONCRETE SHALL BE NORMAL WEIGHT (145 P.C.F.), F'c = 4000 PSI @ 28 DAYS (5 1/2 BAG MIN. CEMENT CONTENT); W/C RATIO 0.45 MAX AND 4% TO 7% AIR ENTRAINMENT. ALL BACKFILL MATERIALS UNDER SLABS SHALL BE FREE

SCALE: N.T.S.

- 4. FILL MATERIALS FOR SLAB AREAS SHALL BE PLACED IN LAYERS NOT EXCEEDING 9" AND COMPACTED TO 95% MINIMUM DENSITY IN ACCORDANCE WITH ASTM D1557 UNTIL FINAL GRADE IS ATTAINED. SLAB AREAS SHALL BE PROOF ROLLED WITH THE HEAVIEST EQUIPMENT AVAILABLE. ALL SOFT SPOTS SHALL BE
- REMOVED AND REPLACED WITH APPROVED FILL MATERIALS.

 5. CALCIUM CHLORIDE, OR ADMIXTURES CONTAINING SAME, SHALL NOT BE PERMITTED IN ANY CONCRETE.
- 6. FLY ASH, IF UTILIZED AND APPROVED (TYPE C OR F), SHALL BE LIMITED TO 15% OF THE TOTAL CEMENT CONTENT.
- 7. COLD WEATHER CONCRETING SHALL BE DONE IN ACCORDANCE WITH ACI-306. HOT WEATHER CONCRETING SHALL BE DONE IN ACCORDANCE WITH ACI-305.

8. PROVIDE ALL ACCESSORIES NECESSARY TO SUPPORT WELDED WIRE FABRIC AT POSITION SHOWN ON THE PLANS AND DETAILS. 9. THE MAXIMUM AGGREGATE SIZE THAT SHALL BE USED IS 3/4". T - Mobile:

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I 100 E. WOODFIELD ROAD, SUITE 500 SCHAUMBURG, ILLINOIS 60173 TEL: 847-908-8400

SITE #:

BA90476A

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SITE ADDRESS:

6021 LEWIS ROAD VACAVILLE, CA 95687

SHEET NAME:

EQUIPMENT AND CONCRETE PAD DETAILS


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SCALE: N.T.S.

C-3

CONCRETE PAD DETAIL

EQUIPMENT ELEVATION

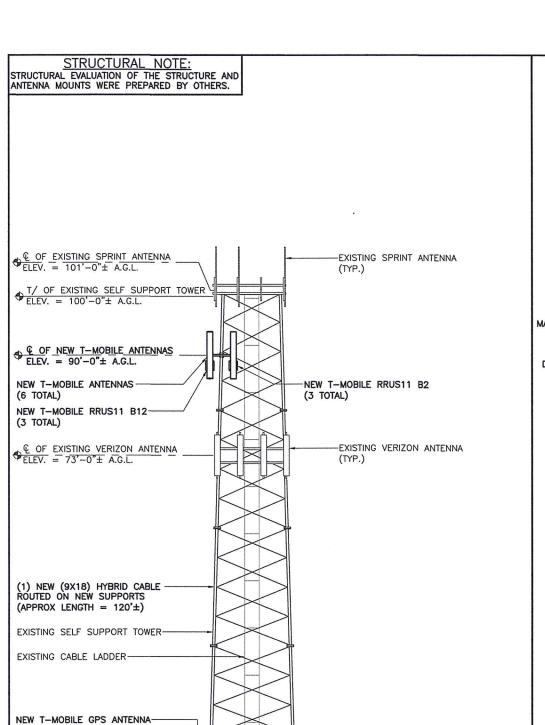

NEW T-MOBILE ICE BRIDGE-

NEW T-MOBILE CABINET-ON NEW CONCRETE PAD


PPC/TELCO CABINETS ON NEW UTILITY H-FRAME

T/GRADE

TOWER ELEVATION VIEW

NEW T-MOBILE-

		ANT	ENNA SCHEDUL	E		
SECTOR	ALF	PHA	BE	TA	GAN	1MA
ANTENNA POSITION	A-1	A-2	B-1	B-2	C-1	C-2
ANTENNA TYPE	LTE AWS/UMTS PCS	LTE	LTE AWS/UMTS PCS	LTE	LTE AWS/UMTS PCS	LTE
AZIMUTH	0°	0°	120*	120°	300°	300°
RAD CENTER (AGL)	90'	90'	90'	90'	90'	90'
MODEL	ERICSSON	ANDREW	ERICSSON	ANDREW	ERICSSON	ANDREW
	AIR 21 B4A B2P	LNX-6515DS-A1M	AIR 21 B4A B2P	LNX-6515DS-A1M	AIR 21 B4A B2P	LNX-6515DS-A1M
FEEDER LENGTH	±15'-0"	±15'-0"	±15'-0"	±15'-0"	±15'-0"	±15'-0"

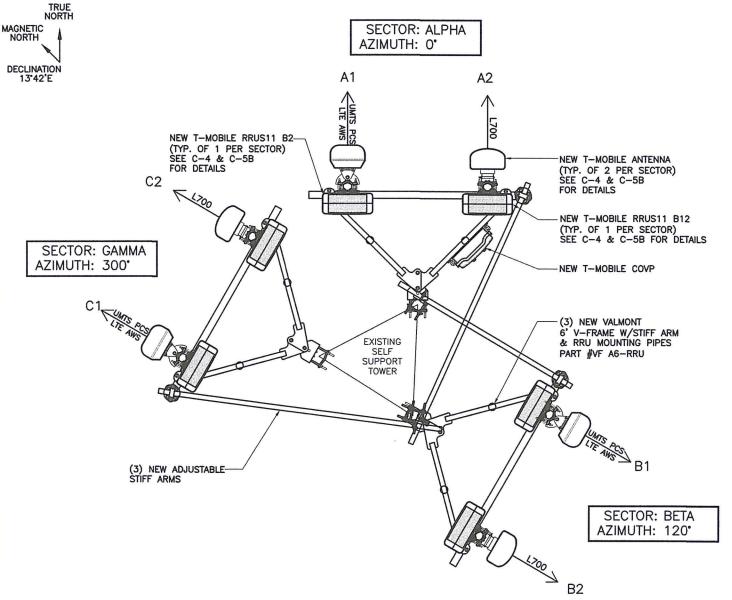



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SHEET NAME:

TOWER ELEVATION AND ANTENNA DETAILS

SHEET NUMBER:

C-4

N

SCALE: 1/16" = 1'-0" 1 ANTENNA LAYOUT

-EXISTING ICE BRIDGE

EXISTING CHAIN LINK-


FENCE W/BARBED WIRE


& PRIVACY SLATS

SHELTER

-EXISTING SPRINT EQUIPMENT

SCALE: 3/8" = 1'-0"

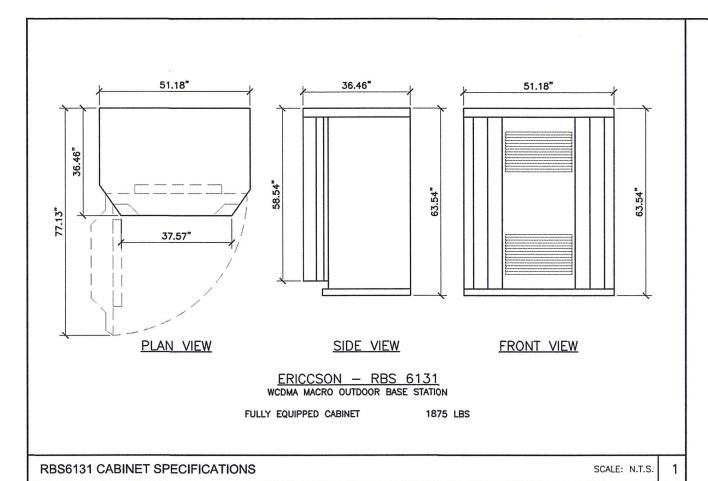

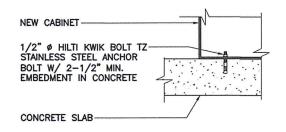

CABINET CONNECTION TO CONCRETE SCALE: N.T.S.



1855 GATEWAY BLVD. SUITE 900 CONCORD, CA 94520

L700 CONSTRUCTION

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1	8/11/16	FINAL	AA





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SHEET NAME:

CABINET DETAILS

SHEET NUMBER:

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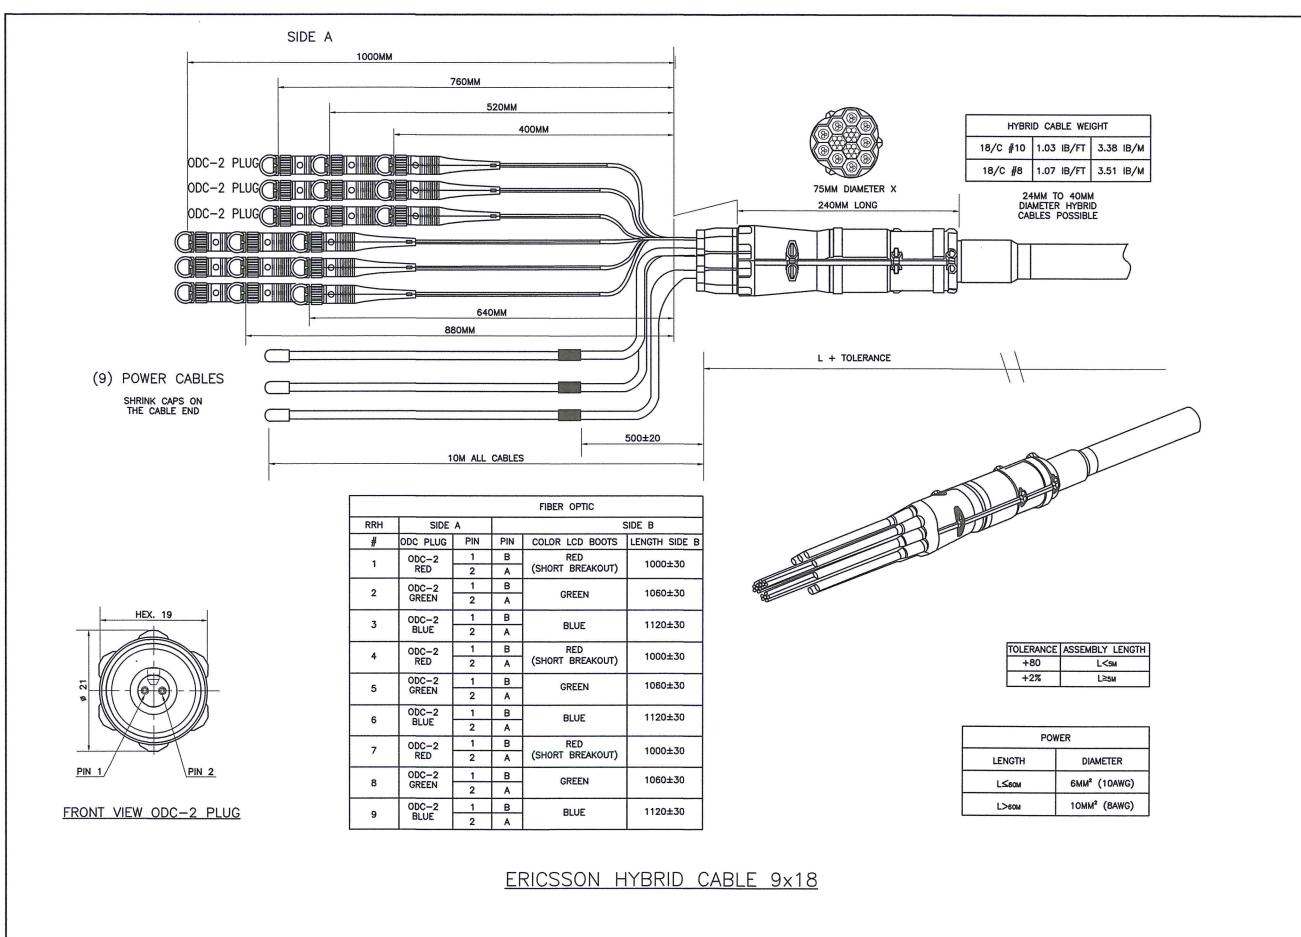
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C-5

CABINET CONNECTION DETAIL

SCALE: N.T.S. 2

NOT USED



T - Mobile:

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1	8/11/16	FINAL	AA	





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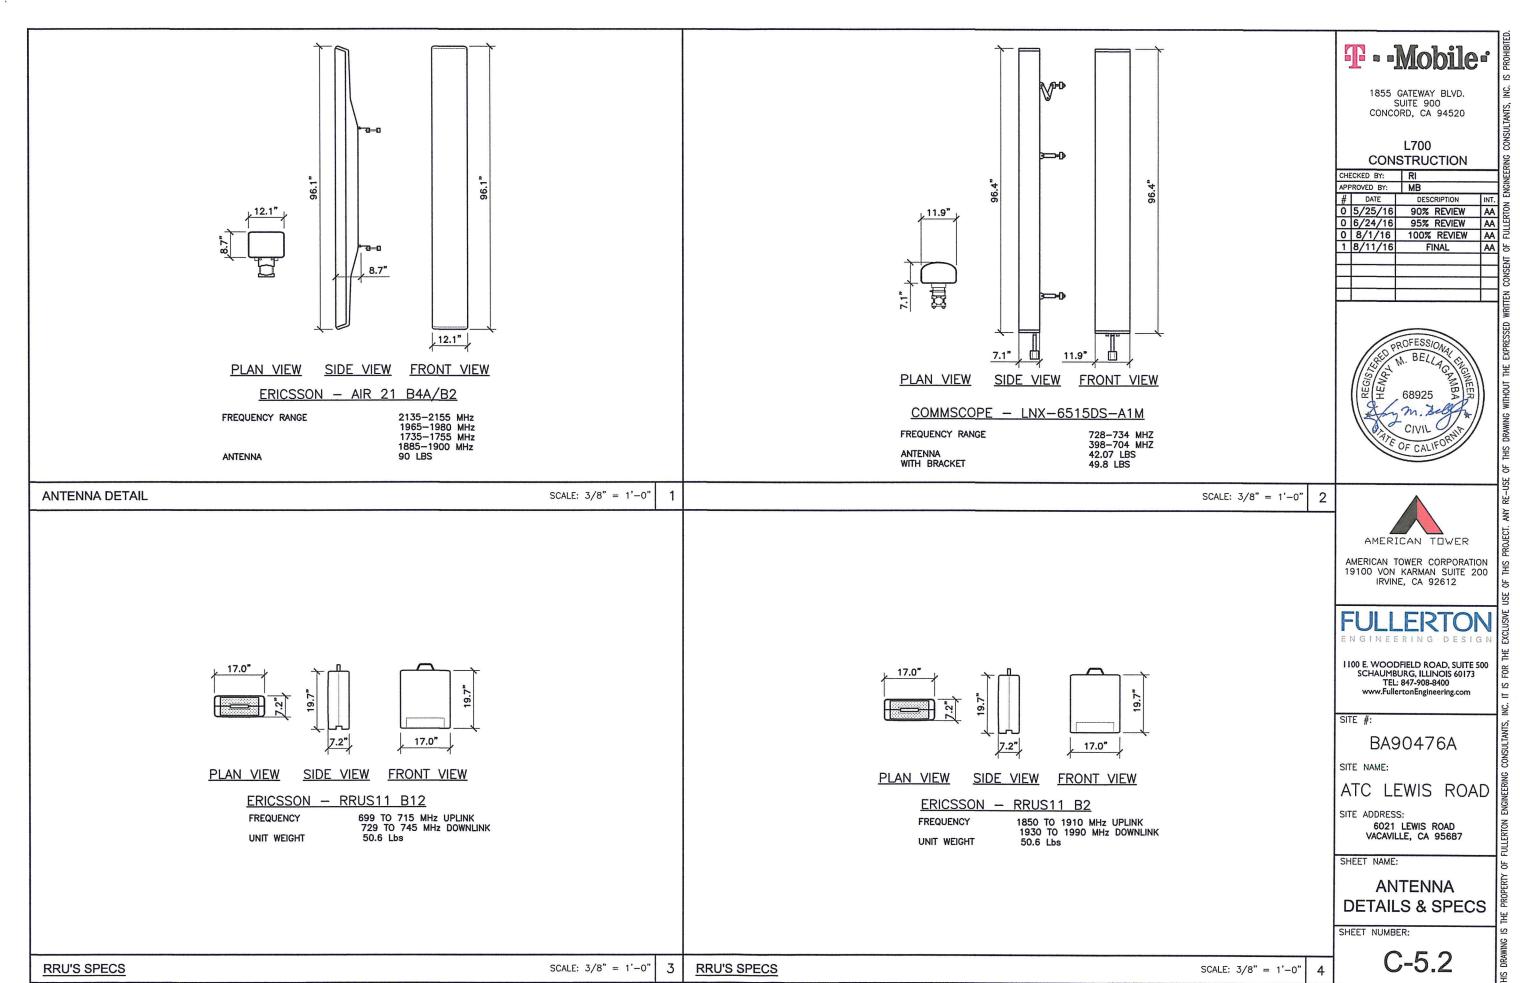
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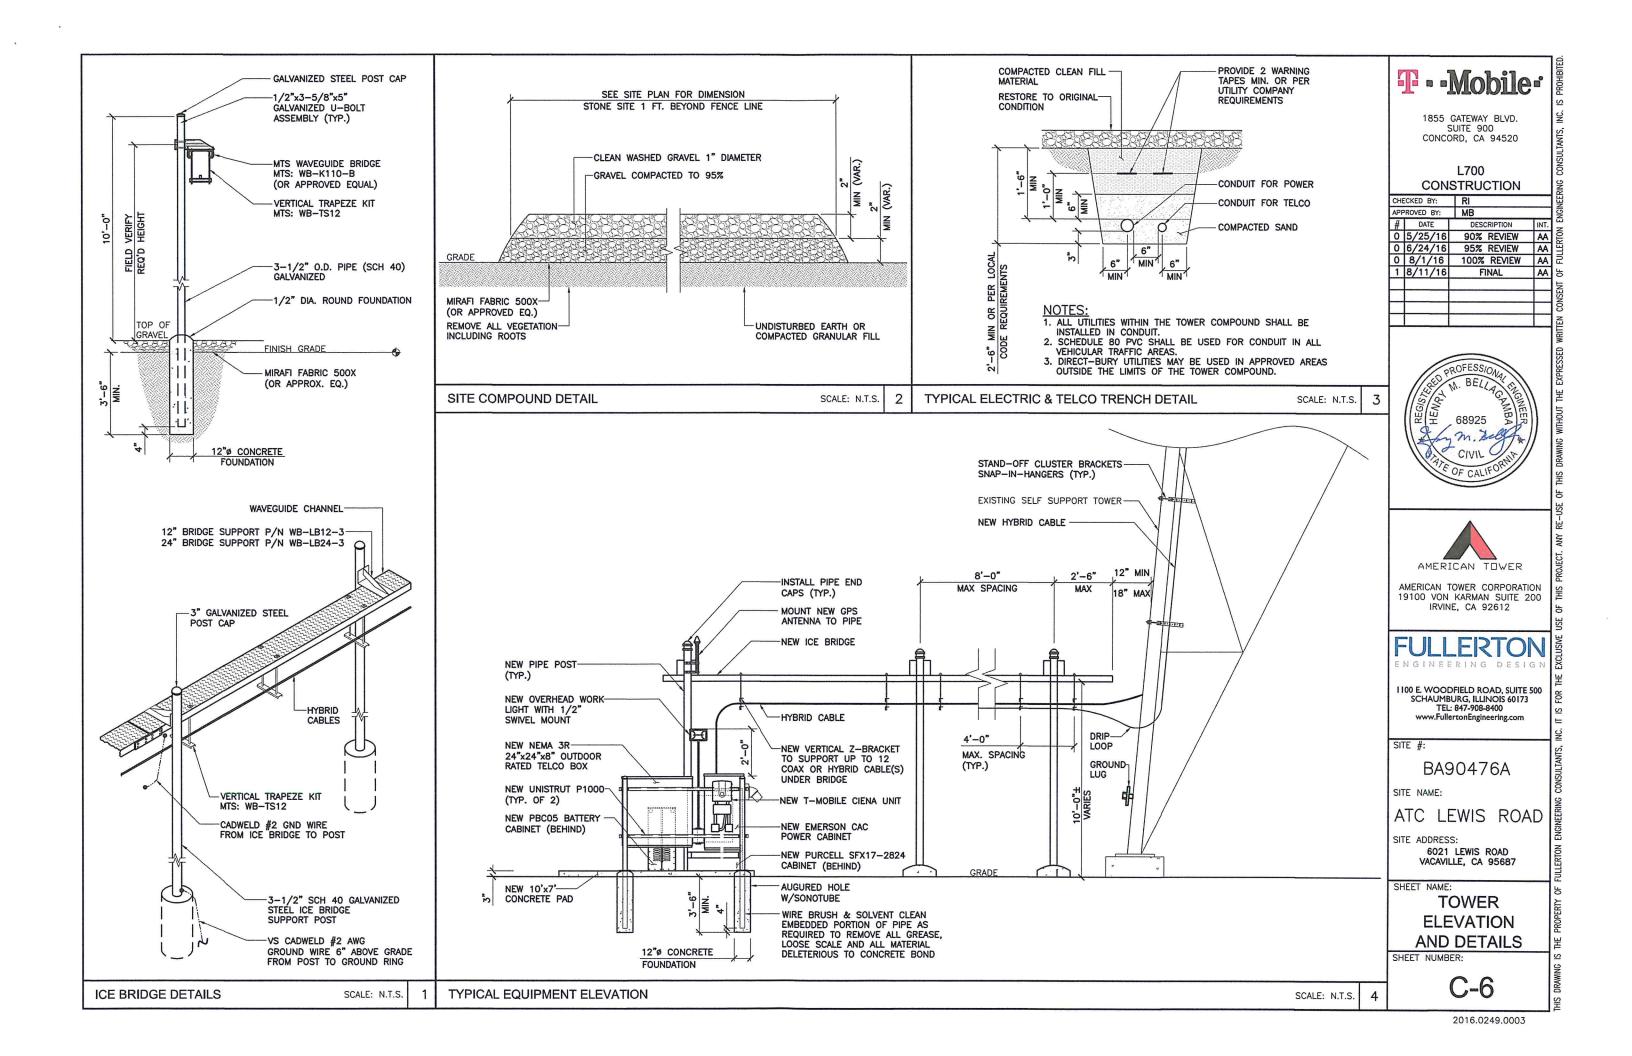
CABLE DETAILS

SHEET NUMBER:

SCALE: N.T.S.

C-5.1





EMERSON CAC POWER CABINET



STANDARD FEATURES:

- NEMA 3R RAINPROOF ENCLOSURE 3-POINT DOOR CLOSURE WITH CONTINUOUS HINGE AND HEAVY DUTY DOOR GASKET
- UL891 LISTED RAIN/DRIP HOOD PROVIDES PROTECTION AGAINST THE ELEMENTS
- O.1" THICK ALUMINUM
 CORROSION RESISTANT POWER COAT PAINT

- CORROSION RESISTANT POWER COAT PAINT
 WALL/BRACKET OR PAD-MOUNTABLE
 OPTIONAL N-G BONDING JUMPER
 MECHANICAL INTERLOCK PREVENTS SIMULTANEOUS USE OF UTILITY
 AND GENERATOR POWER
 BRUTE FORCE METAL OXIDE VARISTOR SURGE SUPPRESSION WITH
 EASY TO READ LED AND REMOTE STATUS INDICATION
 GENERATOR RECEPTACLE OPTIONS INCLUDE: 100A OR 200A, 10kaic
 OR 22kaic, 65kaic

WEIGHT 75 LBS PROTECTION RAIN/DRIP HOOD, RAIN TESTED PER UL891 DISCONNECT SLIDE BAR MECHANICAL INTERLOCK LOAD CENTER 200 AMP, 24 POSITION, 1–30 AMP DOUBLE POLE 1–15 AMP SINGLE POLE		ENCLOSURE		ELECTRICAL
	EXTERNAL MATERIAL DIMENSIONS (WxHxD) WEIGHT PROTECTION CABINET TYPE	20"x39"x10" 75 LBS RAIN/DRIP HOOD, RAIN TESTED PER UL891 ONE AC POWER TVSS CABINET (NEMA 3R	SERVICE DISCONNECT LOAD CENTER BONDING JUMPER POWER RECEPT.	100 AMP OR 200 AMP. UTILITY/STANDBY SLIDE BAR MECHANICAL INTERLOCK 200 AMP, 24 POSITION, 1-30 AMP DOUBLE POLE, 1-15 AMP SINGLE POLE OPTIONAL N-G BONDING JUMPER APPLETON AR20044RS STANDARD

OTHER OPTIONS

SECURITY SAFETY


3-POINT DOOR CLOSURE WITH 1/4 TURN HANDLE, SS HINGE

UL891, DEAD FRONT SWITCHBOARDS OPTIONS

CAC POWER CABINET SPECIFICATIONS

10,000 OR 22,00, 65,000 SERIES RATED, PAD-MOUNTING BASE

(8" THICK), VARIOUS GENERATOR RECEPTACLES OFFERED

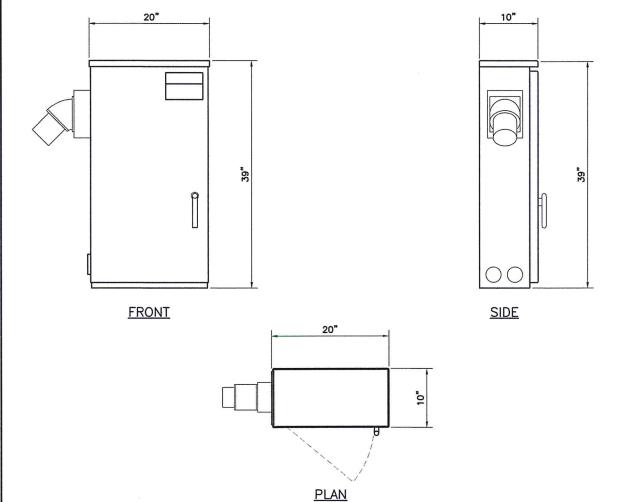

Ordering Information - CAC Model

A small selection of products is listed below.

Please refer to the CAC Model Ordering Matrix for additional configurations.

Emerson Catalog Number	Emerson Part Number	Description	
CACA22204090		100A slide bar transfer device, 24-position load center, ADR1044RS, MOV	
CACA45201090		200A slide bar transfer device, 24-position load center, AR20044RS, MOV	
CACA45201190		200A slide bar transfer device, 24-position load center, AR20044RS with 45 degree angle adapter, MOV	
CACA75201090		200A slide bar transfer device, 30-position load center, AR20044RS, MOV	

Ordering Matrix - CAC Model

AC Power Configuration	2 = 100A main, 24 pos. LC	
	4 = 200A main, 24 pos. LC	
	7 = 200A main, 30 pos. LC	9
AIC Rating	2 = 10KAIC	
	5 = 65K AIC Series Rated	
Main Breakers (Transfer Device)	1 = Single disconnect	
	2 = Slide bar mechanical interlock	
Generator Inlet	00 = None	
	01 = AR20044RS (Appleton 200A)	
	02 = AR20034RS (Appleton 200A)	
	03 = AR20033RS (Appleton 200A)	
	04 = AR1044RS (Appleton 100A)	
	05 = HBL27 15SW (Hubbell 30A)	
	08 = M4100B12W (McGill 100A)	
	09 = HBL4100RS2WR (Hubbell 100A)	
	10 = HBL4100RS1WR (Hubbell 100A)	1
	11 = HBL4200RS1WR (Hubbell 200A)	A second
	12 = 4100B12W (Hubbell 100A)	
	13 = ADR1033RS (Appleton 100A)	14 - Custom Option
Generator Inlet Accessories	0 = No angle adapter	
	1 = 45 degree angle adapter	
TVSS Options	0 = None	
	9= IG120S200RK-WW	



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0	8/1/16	100% REVIEW	AA
1	8/11/16	FINAL	AA





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SITE #:

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SITE NAME:

ATC LEWIS ROAD

SITE ADDRESS:

6021 LEWIS ROAD VACAVILLE, CA 95687

SHEET NAME:

EQUIPMENT DETAILS

SHEET NUMBER:

C-7

SCALE: N.T.S.

CAC POWER CABINET CONFIGURATION

0 = None


Cabinet Mounting

2

Notes:

Section 3 - Proposed Template Images

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T - Mobile -
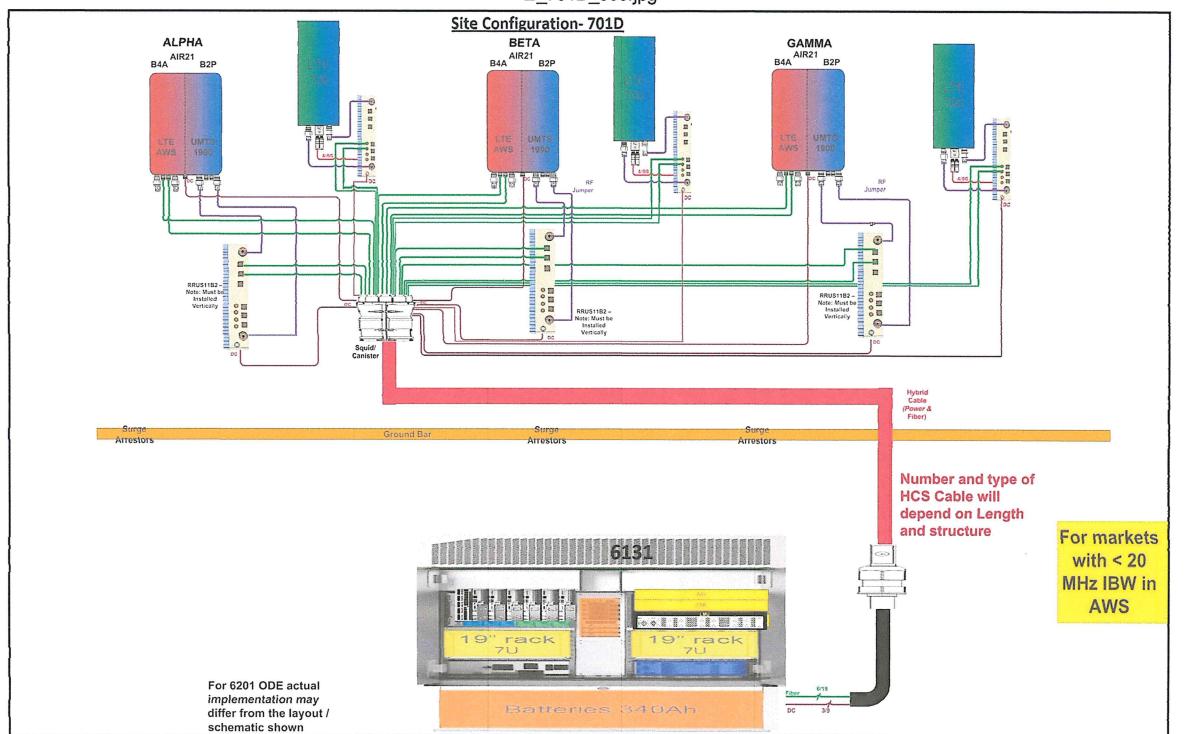
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1	8/11/16	FINAL	AA





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SITE #

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SHEET NAME:

RFDS SHEET

SHEET NUMBER:

C-8

16 0249 0003



20 AMP OUTDOOR GFCI & SWITCH COMBO NOT TO SCALE

INSTALL OF ELECTRICAL METER WITH UTILITY COMPANY AND VERIFY INSTALLATION WITH T-MOBILE.

ELECTRICAL CONTRACTOR NOTE

THESE ELECTRICAL DRAWINGS ARE DIAGRAMMATIC
CONLY AND SHOW THE GENERAL INTENT OF THE FINAL
ARRANGEMENT OF ELECTRICAL SYSTEMS, EQUIPMENT
AND CONNECTIONS, IT IS THE INTENT OF THESE
ELECTRICAL DRAWINGS TO REQUIRE APPROPRIATE
ELECTRICAL WORK TO COMPLETELY FACILITATE THE
ELECTRICAL REQUIREMENTS FOR THE NEW TENANT (T
MOBILE). SOME OF THE ELECTRICAL WORK SHOWN IS
EXISTING AND SHALL REMAIN IN PLACE AND NEW
WORK ADDED TO ACCOMMODATE T-MOBILE
ELECTRICAL REQUIREMENTS. CONTRACTOR SHALL FIELD
VERIFY ALL EXISTING ELECTRICAL EQUIPMENT AND
WIRING AND ADD NEW WORK, AS REQUIRED TO
COMPLETE THE T-MOBILE ELECTRICAL REQUIREMENTS. IT
IS NOT INTENDED TO SHOW EVISTING ELECTRICAL
WORK EXACTLY AS IS, BUT TO SHOW THE INTENT ONLY.
CONTRACTOR SHALL COORDINATE WITH UTILITY
COMPANY'S FOR ADDED LOAD (T-MOBILE). VERIFY
ELECTRICAL AND TELEPHONE SERVICE SIZE AND CAP. MANUFACTURER: GENERAL ELECTRIC

GENERAL NOTES

(OR EQUIVALENT)

Ù010S010GRP

5.2" 7.1"

5.8

3.92 LBS

1-UL LISTED

I) ALL WORK IS TO COMPLY WITH THE LATEST EDITION OF THE NATIONAL ELECTRIC CODE (N.E.C.) AND ANY LOCAL ORDINANCES, CODES AND ALL OTHER ADMINISTRATIVE AUTHORITIES HAVING JURISDICTION. THE CONTRACTOR SHALL FURNISH AND PAY FOR ALL PERMITS AND RELATED FEES.

2) ALL EQUIPMENT AND -MATERIAL FURNISHED AND INSTALLED UNDER THIS CONTRACT SHALL BE UNDERWRITERS LABORATORIES (U.L) LISTED, NEW, FREE FROM DEFECTS AND SHALL BE GUARANTEED FOR A PERIOD OF ONE YEAR FROM DATE OF FINAL ACCEPTANCE BY OWNER OR HIS REPRESENTATIVE. SHOULD ANY TROUBLE DEVELOP DURING THIS PERIOD DUE TO FAULTY WORKMANSHIP, MATERIAL OR EQUIPMENT, THE CONTRACTOR SHALL FURNISH ALL NECESSARY MATERIALS AND LABOR TO CORRECT THE TROUBLE WITHOUT COST TO THE OWNER.

3) ALL WORK SHALL BE EXECUTED IN A WORKMAN LIKE MANNER AND SHALL PRESENT A NEAT MECHANICAL APPEARANCE WHEN COMPLETED. CONTRACTOR SHOULD AVOID DAMAGE TO EXISTING UTILITIES WHEREVER POSSIBLE. THE CONTRACTOR SHALL BE. RESPONSIBLE FOR ALL CUTTING AND PATCHING RELATED TO ELECTRICAL WORK, AND SHALL RESTORE ALL EXISTING LANDSCAPING, SPRINKLER SYSTEMS. CONDUITS, WIRING, PIPING, ETC. DAMAGED BY THE FIFCTRICAL WORK TO MATCH CONDITIONS. ELECTRICAL WORK TO MATCH CONDITIONS.

4) ELECTRICAL WORK SHALL INCLUDE, BUT NOT BE LIMITED TO, ALL LABOR, MATERIALS AND EQUIPMENT REQUIRED TO COMPLETE ELECTRICAL POWER AND LIGHTING SYSTEMS, TELEPHONE AND COMMUNICATION SYSTEMS, PANEL BOARDS, CONDUIT, CONTROL WRING, GROUNDING, ETC. AS INDICATED ON ELECTRICAL ELECTRICAL WORK SHALL INCLUDE, BUT NOT BE DRAWINGS AND/OR AS REQUIRED BY GOVERNING CODES.

PRIOR TO INSTALLING ANY ELECTRICAL WORK,

THE CONTRACTOR SHALL VISIT THE JOB SITE AND VERIFY EXISTING SITE LOCATIONS AND CONDITIONS AND UTILITY SERVICE REQUIREMENTS OF THE JOB, AND BY REFERENCE TO ENGINEERING AND EQUIPMENT SUPPLIERS DRAWINGS. SHOULD THERE BE ANY QUESTION OR PROBLEM CONCERNING THE NECESSARY PROVISIONS TO BE MADE, PROPER DIRECTIONS SHALL BE OBTAINED BEFORE PROCEEDING WITH ANY WORK.

6) PROVIDE POWER AND TELEPHONE TO SERVICE POINTS PER UTILITY COMPANY REQUIREMENTS. CONTRACTOR SHALL CONTACT UTILITY SERVICE PLANNERS AND OBTAIN ALL SERVICE REQUIREMENTS. AND INCLUDE COSTS SUCH IN THEIR BID.

7) SERVICE EQUIPMENT SHALL HAVE A SHORT CIRCUIT WITHSTAND RATING EQUAL TO OR EXCEEDING THE MAXIMUM AVAILABLE FAULT CURRENT AT THE SUPPLY TERMINAL ON THE UTILITY TRANSFORMER SECONDARY, THE INSULATION SHALL BE FREE FROM ANY SHORT CIRCUITS AND GROUNDS.

8) WHERE APPLICABLE CONTRACTOR SHALL COORDINATE WILOCAL UTILITY COMPANY REGARDING REQUIREMENTS & INSTALLATION OF A CT CABINET.

ELECTRICAL NOTES

I) ALL WIRES SHALL BE STRANDED COPPER WITH THHNITHWN AND 600 VOLTS INSULATION, ALL GROUND CONDUCTORS TO BE PROPERLY SIZED COPPER, (STRANDED OR SOLID).

2) IN THE EVENT OF ANY CONFLICT OR

INCONSISTENCY BETWEEN ITEMS SHOWN ON THE PLANS AND/OR SPECIFICATIONS, THE NOTE, SPECIFICATION OR CODE WHICH PRESCRIBES AND ESTABLISHES THE HIGHEST STANDARD OF PERFORMANCE

3) SERVICE CONDUITS SHALL HAVE NO MORE THAN (4) -90' BENDS IN ANY SINGLE RUN. THE CONTRACTOR SHALL PROVIDE PULL BOXES AS NEEDED WHERE CONDUIT REQUIREMENTS EXCEED THESE CONDITIONS. PULL WIRES AND CAPS SHALL BE PROVIDED AT ALL SPARE CONDUITS FOR FUTURE USE.

4) ALL COAX, POWER AND TELEPHONE SYSTEM CONDUITS SHALL HAVE A MINIMUM 24- SCH. 80 PVC RADIUS SWEEPS TO EQUIPMENT, PULL BOXES. MONOPOLE. ETC., UNLESS OTHERWISE NOTED. OR AS REQUIRED BY UTILITY COMPANIES.

5) ALL CONDUIT AND NIPPLE ENTRIES TO CABINET AND METER BOXES WILL BE MADE WITH WEATHERPROOF HUBS, CONNECTORS OR LOCKNUTS LISTED FOR THE APPLICATIONS. NON-METALLIC

6) ONLY ONE SERVICE ALLOWED PER LUG. ALL GROUNDING AND BONDING MUST COMPLY WITH NEC

7) UPON COMPLETION OF THE JOB, THE CONTRACTOR SHALL FURNISH AS-BUILT DRAWINGS TO THE OWNER.

T - Mobile:

1855 GATEWAY BLVD. SUITE 900 CONCORD, CA 94520

L700 CONSTRUCTION

CHECKED BY:		RI	
APF	PROVED BY:	MB	
#	DATE	DESCRIPTION	INT.
0	5/25/16	90% REVIEW	AA
0	6/24/16	95% REVIEW	AA
0	8/1/16	100% REVIEW	AA
1	8/10/16	FINAL	I AA

20 AMP OUTDOOR GFCI AND SWITCH COMBO

MODEL:

DEPTH:

HEIGHT:

WIDTH:


WEIGHT:

UL LISTING:

VOLTAGE:

MAX. AMPERAGE: 20 A

SCALE: N.T.S.

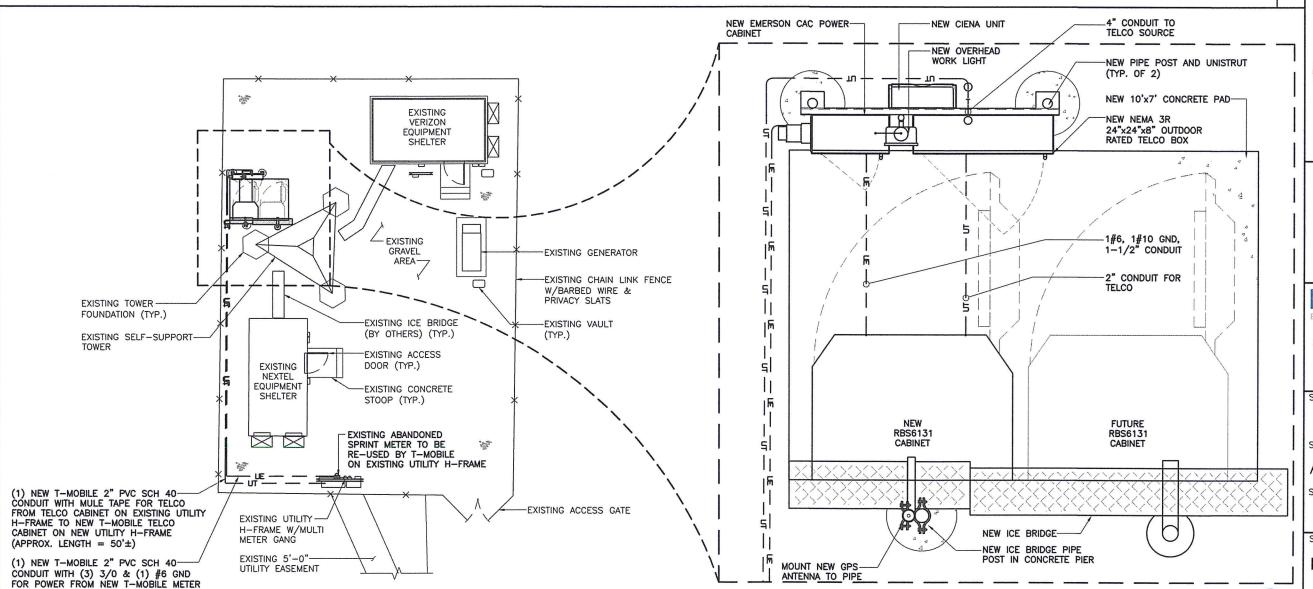

PECTRICA

E 20363



AMERICAN TOWER CORPORATION 19100 VON KARMAN SUITE 200 IRVINE, CA 92612

1100 E. WOODFIELD ROAD, SUITE 500 SCHAUMBURG, ILLINOIS 60173 TEL: 847-908-8400 www.FullertonEngineering.com

SITE #:

BA90476A

SITE NAME:

ATC LEWIS ROAD

6021 LEWIS ROAD VACAVILLE, CA 95687

SHEET NAME:

ELECTRICAL PLAN AND NOTES

SHEET NUMBER:


ELECTRICAL PLAN


(APPROX. LENGTH = $50'\pm$)

H-FRAME

ON EXISTING UTILITY H-FRAME TO NEW T-MOBILE PPC CABINET ON NEW UTILITY

> SCALE: 1/16" = 1'-0"2

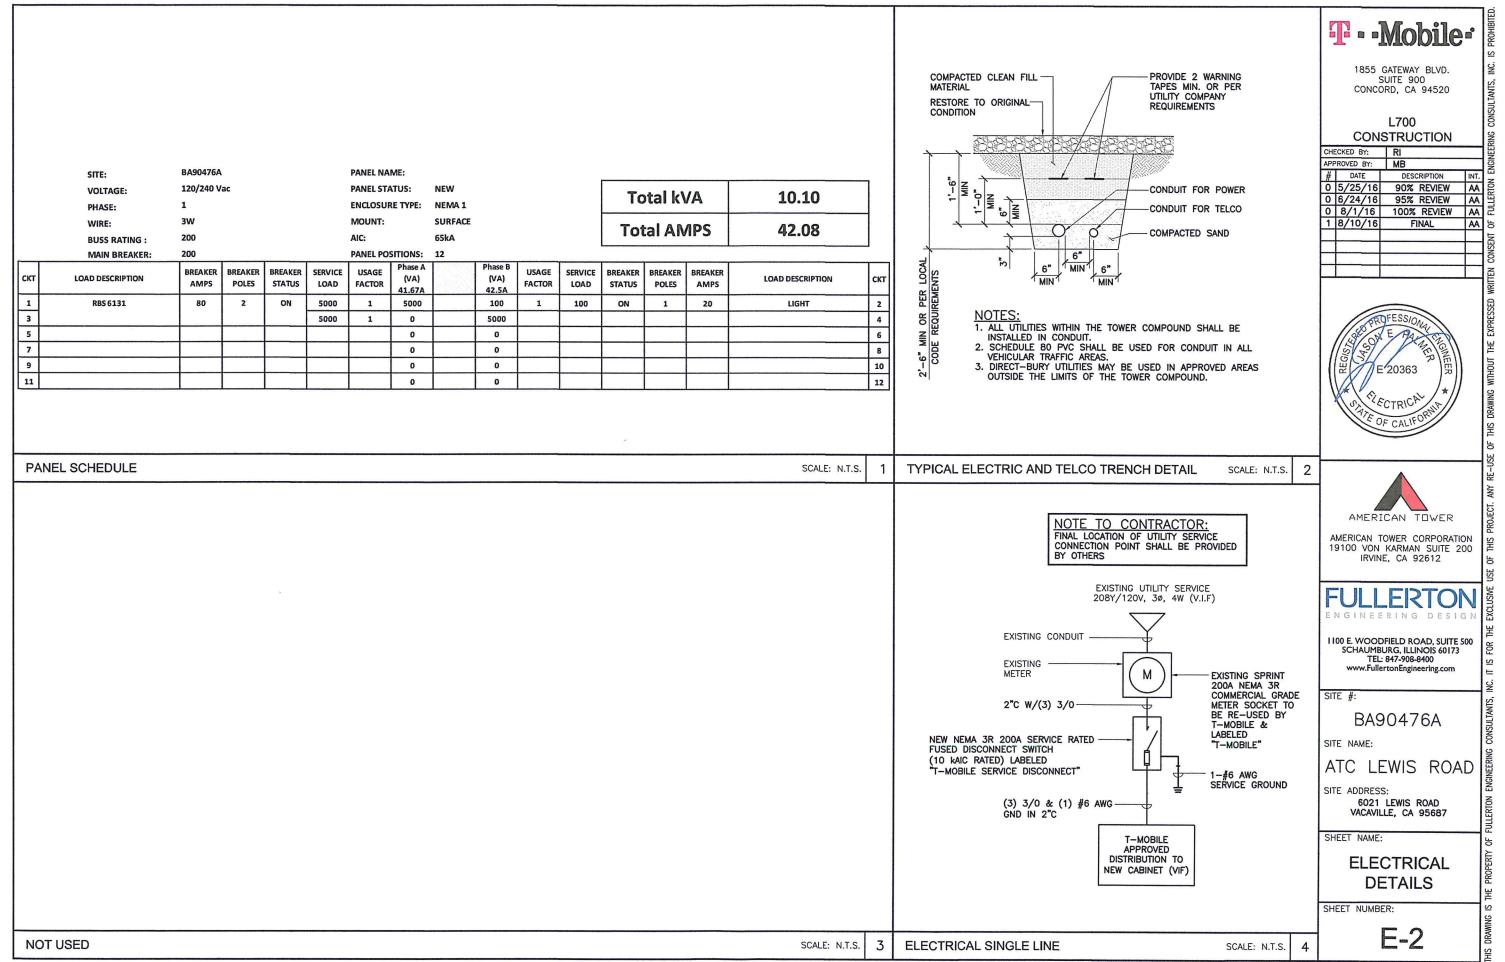

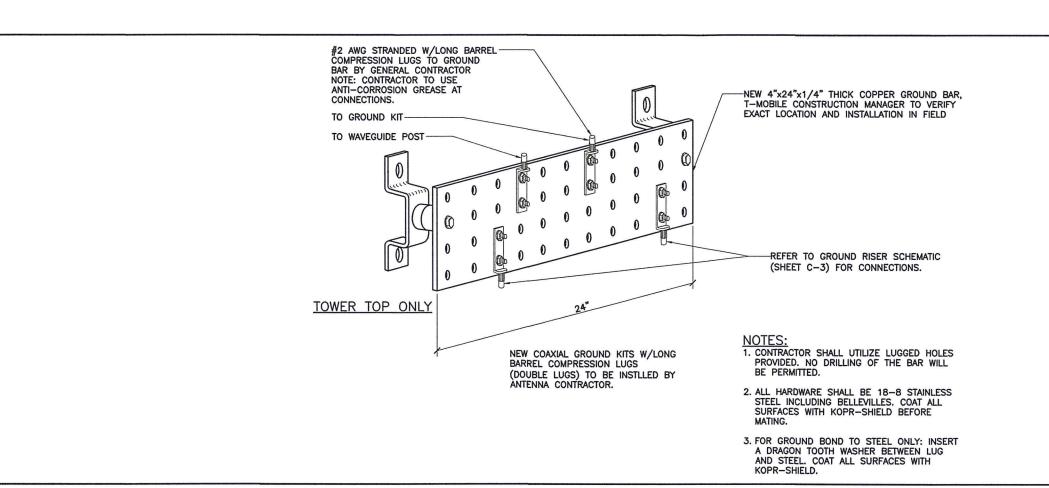



1855 GATEWAY BLVD. SUITE 900 CONCORD, CA 94520

L700 CONSTRUCTION

CHECKED BY: APPROVED BY:		RI	
		MB	
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1	8/10/16	FINAL	AA
			I



AMERICAN TOWER

AMERICAN TOWER CORPORATION 19100 VON KARMAN SUITE 200

IRVINE, CA 92612

I 100 E. WOODFIELD ROAD, SUITE 500 SCHAUMBURG, ILLINOIS 60173 TEL: 847-908-8400

TYPICAL GROUNDING BAR DETAIL


TEST WELL DETAIL


SCALE: N.T.S.


2

CALDWELD "TYPES" SHOWN ARE EXAMPLES.
CONSULT WITH CONSTRUCTION MANAGER FOR SPECIFIC TYPES OF CALDWELDS TO BE USED FOR THIS PROJECT.

CADWELL CONNECTION TYPES

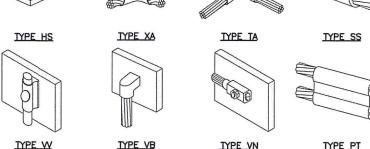

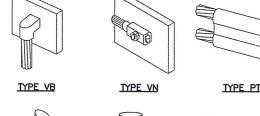

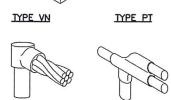






TYPE NO

SCALE: N.T.S.



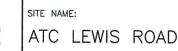

SITE ADDRESS: 6021 LEWIS ROAD VACAVILLE, CA 95687

SHEET NAME:

SITE #:

GROUNDING **DETAILS**

SHEET NUMBER:

HARGER #360P-42 10" PVC TEST WELL WITH HARGER #10PS 10-5/8" STEEL TEST WELL COVER TOP OF GRAVEL T/GRADE -3/4" CRUSHED STONE OR EQUAL FILL TEST WELL TO WITHIN 8" OF TOP #2 SOLID TINNED COPPER CADWELD CONNECTION (TYPE-GT) #2 AWG SOLID TINNED BARE — COPPER WIRE CADWELD CONNECTION TO GROUND ROD 5/8" x 10' LONG COPPER CLAD GROUND ROD CADWELD CONNECTION (TYPE-PT)

TYPE GT TYPE 2-YA-2


TYPE GY

TYPE VS

TYPE GR

TYPE YA-2

SCALE: N.T.S.

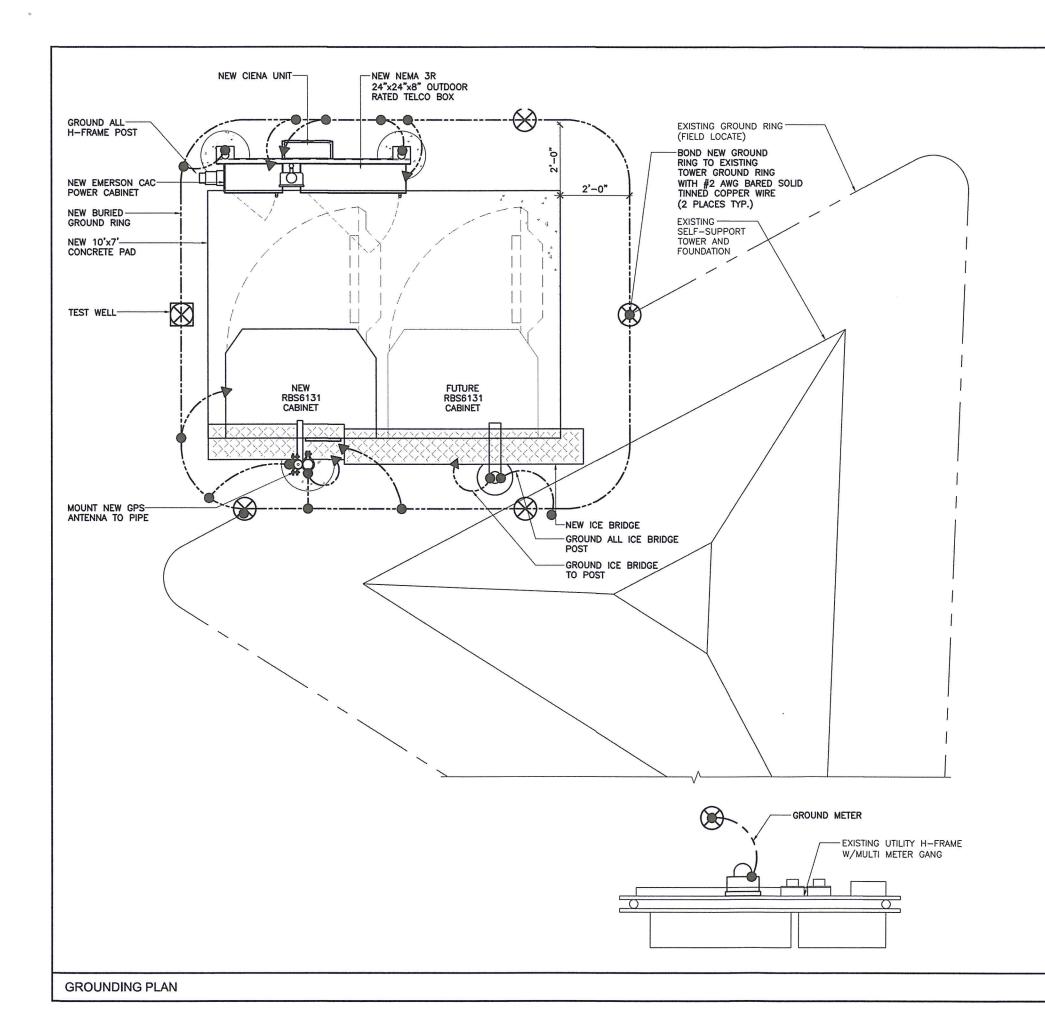

GROUNDING / CABLE NOTES:

INSTALL 2 GROUND BARS AT THE BOTTOM OF THE TOWER (EVEN WITH SHORT ICE BRIDGE RUNS). ONE GROUND BAR AT THE TOWER, AND ON AT THE PLATFORM. IF SITE IS A ROOFTOP AND THE EQUIPMENT IS IN THE PENTHOUSE. T-MOBILE REQUIRES ONE GROUND BAR ON THE OUTSIDE OF THE PORT ENTRY AND ONE ON THE INSIDE NEAR THE CABINET. MONOPOLE JOBS WILL REQUIRE SECTORIZED GROUNDING, WHICH WILL REQUIRE 3 TOP BUSS BARS.

- T-MOBILE IS ELIMINATING THE HOME RUN GROUND WIRE FROM THE TOP BUSS BAR TO THE BOTTOM BUSS BAR ON TOWER SITES. ROOFTOPS ARE STILL REQUIRED TO HAVE SECTORIZED GROUND AND #2 INSULATED GROUND WIRE. FROM SECTOR GROUNDS TO MAIN BUSS BARS AND BUILDING STEEL.
- REMOVE INSULATORS (CHERRIES) FROM THE BUSS BARS AND GROUND TO TOWER, TOP AND BOTTOM ON TOWER SITES ONLY.
- ALL EXPOSED GROUNDS TO BE DRESSED WITH SEAL
- ALL ICE BRIDGE POST ARE TO BE GROUNDED WITH #2 SOLID AND DRESSED IN SEAL TIGHT.
- (2) OF THE (4) PLATFORM POST NEED TO BE GROUNDED DIAGONALLY.
- BOTTOM BUSS BAR TO HAVE TWO #2 GROUND LEADS DRESSED IN WITH SEAL TIGHT.
- 8. THE DISTANCE BETWEEN TRAPEZE HANGERS ON ICE BRIDGE IS 4'-0".
- 9. THE DISTANCE BETWEEN BUTTERFLIES AND CABLE STAND OFFS IS 4'-0".
- 10. THE DISTANCE BETWEEN CONVENTIONAL AND/OR SNAP-HANGERS ON 1/2" JUMPERS SHALL BE NO MORE THAN 3 FEET AT THE TOP AND 2 FEET ON THE BOTTOM JUMPERS PER MANUFACTURER'S RECOMMENDATIONS.
- 11. NO HYBRID CABLES SHALL TOUCH METAL OR STEEL. THE USE OF STANDOFF BRACKETS ARE REQUIRED.
- 12. T-MOBILE WOULD LIKE TO SHORTEN THE TOP JUMPER TO 4'-0" SUREFLEZ, INSTEAD OF 6'-0". JUMPERS SHOULD NOT BE CURLED UP OR COILED TO ELIMINATE
- 13. GRAVEL UNDER ALL PLATFORMS IS REQUIRED.
- 14. HYBRIDS AND JUMPER LINES SHOULD BE DRESSED IN ON THE SIDE OR BOTTOM OF T-BOOMS. NEVER ON TOP WERE SOMEONE WOULD WALK.

GROUNDING LEGEND

- INSPECTION WELL VERIFY LOCATION 5 W/CONSTRUCTION MANAGER
- 5/8"x10'-0" COPPER CLAD GROUND ROD, 10' O.C. (TYP.)

#2 AWG SOLID COPPER TINNED

GROUND BUS BAR

EXOTHERMIC CONNECTION

MECHANICAL CONNECTION

1855 GATEWAY BLVD. SUITE 900 CONCORD, CA 94520

L700 CONSTRUCTION

S APPROVED BY: MB # DATE DESCRIPTION	
	INT.
0 5/25/16 90% REVIEW	AA
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SITE #:

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SITE NAME:

ATC LEWIS ROAD

SITE ADDRESS:

6021 LEWIS ROAD VACAVILLE, CA 95687

SHEET NAME:

GROUNDING PLAN AND NOTES

SHEET NUMBER:

SCALE: 3/8" = 1'-0"